DRAWING SCHEDULE DEVELOPMENT APPLICATION

ARCHITECTURAL AND LANDSCAPE DRAWINGS 17-0049

DA/01	Cover Sheet & Location Plan	DA/21	Site Sections and Height Envelope Review
DA/02	The Cosgrove - A Unique Opportunity	DA/22	Dwelling Typologies Sheet 1 of 2
DA/03	Site Analysis Plans	DA/23	Dwelling Typologies Sheet 2 of 2
DA/04	Site Analysis Plans and Building Summary	DA/24	Adaptable Dwelllings - Pre and Post Adaptation Plan
DA/05	Site Operational and Management Plans	DA/25	Adaptable Dwelllings - Pre and Post Adaptation Plan
DA/06	Proposed Site Plan & Roof Plan	DA/26	Site Shadow Diagrams Sheet 1 of 2
DA/07	Building 1 & Utilities Management Area Floor Plans	DA/27	Site Shadow Diagrams Sheet 2 of 2
DA/08	Building 1 & Utility Area – Elevations & Sections	DA/28	Dwelling Solar Access Sheet 1 of 2
DA/09	Building 2 Lower Ground and Ground Level Floor Plans	DA/29	Dwelling Solar Access Sheet 2 of 2
DA/10	Building 2 Upper Ground Floor Plan	DA/30	External Materials & Colour Palette
DA/11	Building 2 Level 1 Floor Plan	DA/31	Building Area Types & Area Schedules
DA/12	Building 2 – Elevations & Section	DA/49	Retained & Removed Trees
DA/13	Building 3 Lower Ground and Ground Level Floor Plans	DA/50	Landscape Masterplan
DA/14	Building 3 Upper Ground Level and Level 1 Floor Plans	DA/51	Part Landscape Plan 1
DA/15	Building 3 – Elevations & Section	DA/52	Part Landscape Plan 2
DA/16	Building 4 Lower Ground Level & Ground Level Floor Plans	DA/53	Part Landscape Plan 3
DA/17	Building 4 Upper Ground Level and Level 1 Floor Plans	DA/54	Communal Open Space
DA/18	Building 4 – Elevations & Section	DA/55	Landscape Typical Details
DA/19	Building 5 Ground Level and Level 1 Floor Plans	DA/56	Landscape Perspectives
DA/20	Building 5 – Elevations & Section	DA/57	Planting Palette



Image sourced from Google Earth. Not to scale



- 1 Subject Site
- 2 University Of Wollongong Main Campus (0.6KM)
- 3 Wollongong Botanic Garden (0.9KM)
- 4 MT Keira Lookout (1.2KM)
- 5 Wollongong TAFE Campus (1.7KM)
- 6 Keiraville Public School (0.8KM)
- 7 Keiraville Village Centre (0.8KM)
- 8 North Wollongong Train Station (2.1KM)
- 9 M1 Freeway. Access to Sydney and Canberra (1.3KM)
- 10 Fairy Meadow Village Centre (2.3KM)
- 11 University Of Wollongong Innovation Campus (2.7KM)
- 12 Wollongong Central Business District (2.9KM)
- 13 Wollongong Harbour (3.4KM)
- 14 UOW Bus Stop (Free Green Bus Service (3.4KM)
- 15 Kooloobong Park, Public Reserve (0.1KM)



FAHRENHEIT GLOBAL
AN INTERNATIONAL FIRE ENGINEERING CONSULTANCY















urbaine architecture pty 1td







Project

Proposed Residential Development THE COSGROVE

Surewin Parkview Pty Ltd

Location

Lot 90 in D.P. 1086429, 14 Cosgrove Avenue, Keiraville, NSW, 2500



Edmiston Jones

Wollongong

Level 1/147 Crown Street, Wollongong NSW 2500 T: 02 4226 1387


Nowra 92 North Street

6/9-11 Orient Street Nowra, NSW 2541 Batemans Bay T: 02 4421 6822 NSW 2536 T: 02 4472 7388

W: www.aej.com.au

DA/01

E: aej@aej.com.au

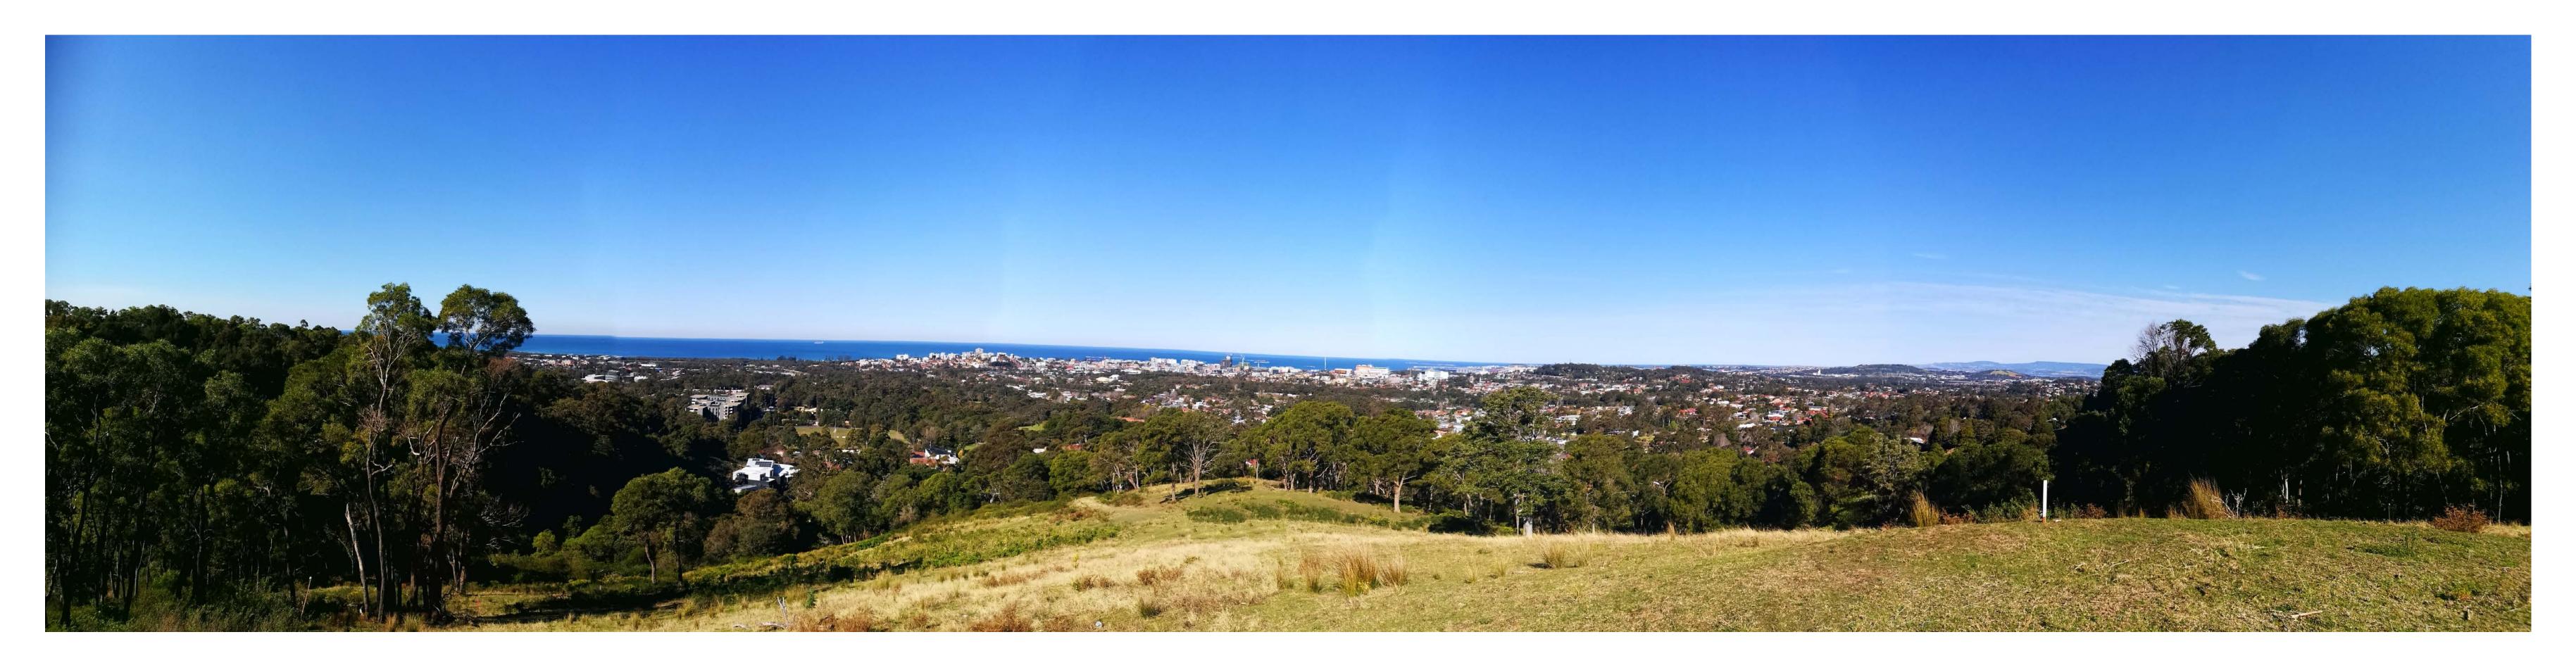

The Cosgrove


"Living within the foothills of the Illawarra Escarpment, seeing beyond to the coastline of the Tasman Ocean"


A site is unique to the Illawarra:

- Nestled into the base of the Illawarra Escarpment where the native
- vegetation meets the built form of the Illawarra region.

 360 degree views ranging from the Illawarra Escarpment to the coastline of the Tasman Sea.
- Three key design objectives where set to address the sites unique features:

- The builtform is to be integrated into the landscape to allow it sit within its surrounding environment.
 The builtform is to be inspired by the surrounding natural landforms, materials, textures and colours.
 The buildings are to be designed so that they take full advantage of the views to the coast whilst respecting the privacy and amenities of the adjoining community.

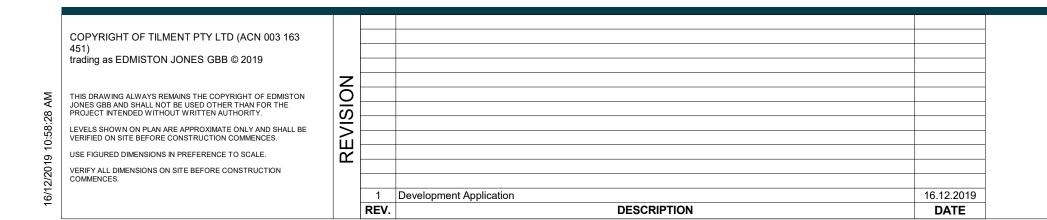

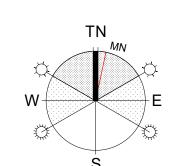


For Surewin Parkview Pty Ltd Proposed Residential Development THE COSGROVE At Lot 90 in D.P. 1086429, 14 Cosgrove Avenue,

Keiraville, NSW, 2500 WOLLONGONG NOWRA BATEMANS BAY T 02 4226 3600 T 02 4421 6822 T 02 4472 7388 **W** www.aej.com.au **E** aej@aej.com.au Nominated Architect Steven Bayer Reg. No. 5880

DRAWING TITLE: The Cosgrove - A Unique Opportunity SCALE: @ B1 DRAWN: CHECKED: DATE: MFJ 16.12.2019 17-0049





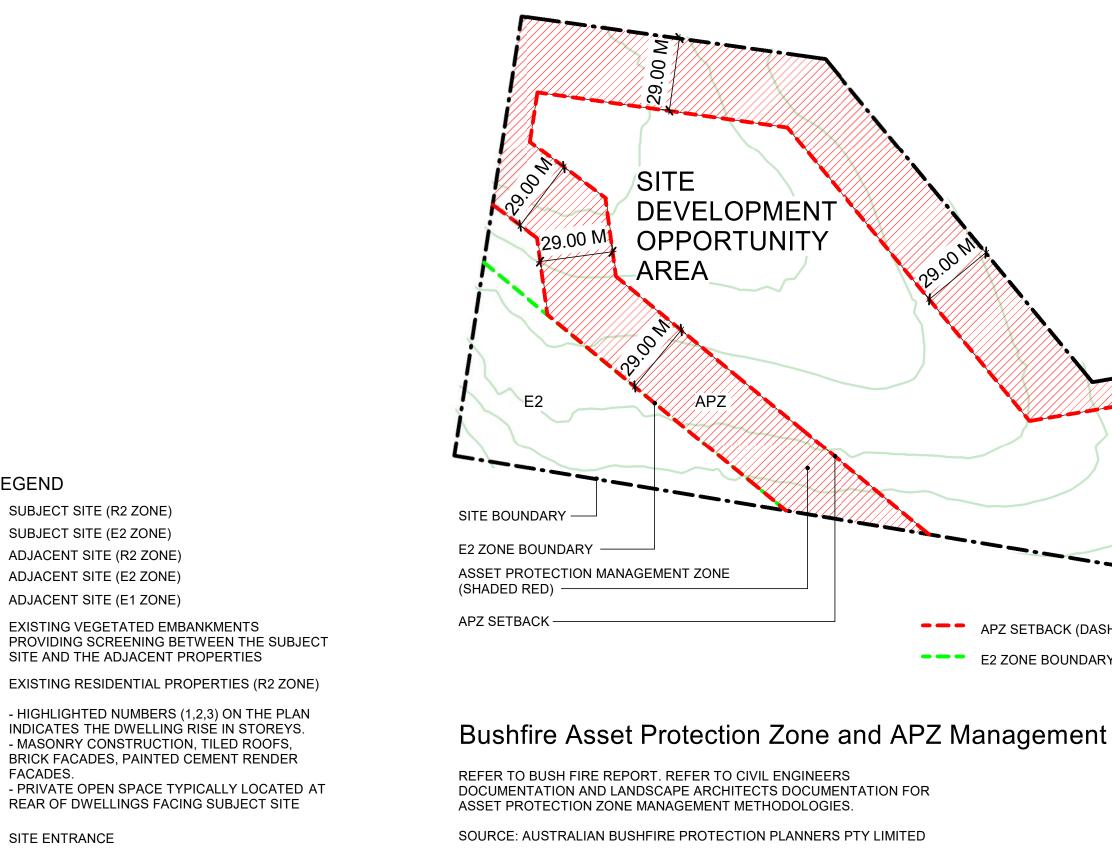


SUBJECT SITE (R2 ZONE)

2 SUBJECT SITE (E2 ZONE)


ADJACENT SITE (E1 ZONE)

SITE ENTRANCE


EXISTING VEGETATED EMBANKMENTS

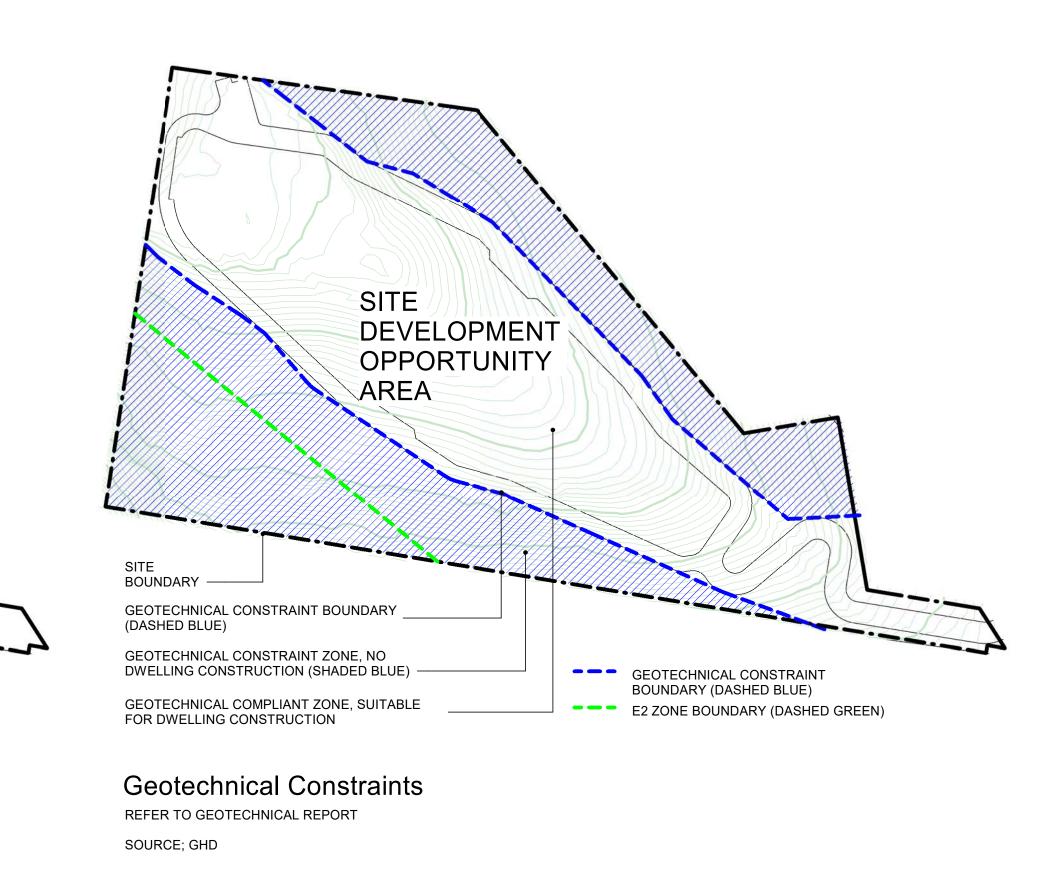

Local Context Plan

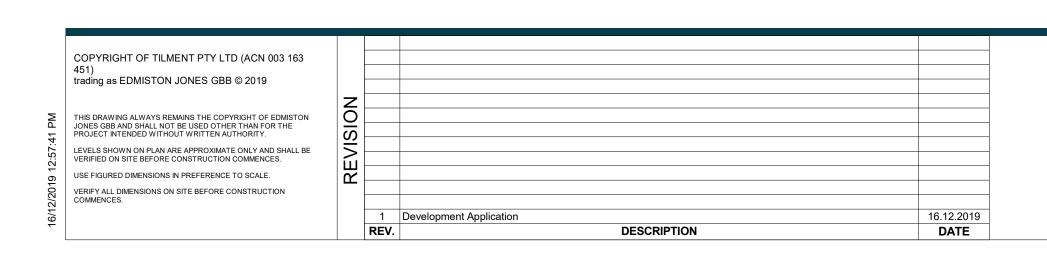



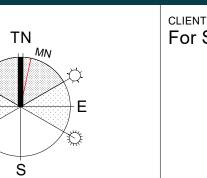

APZ SETBACK (DASHED RED)


E2 ZONE BOUNDARY (DASHED GREEN)


r Surewin Parkview Pty Ltd		sed Residentia COSGROVE	al Developm	ent	DRAWING TITLE: Site Analysis	Plans	s
	At Lot	90 in D.P. 108	86429 14 Ca	osgrove Avenue,	SCALE: @ B1	DRAW	/N:
		/ille, NSW, 250	•	osgiove / weilde,	NOT TO SCALE	E	J
		,,					
		WOLLONGONG	NOWRA	BATEMANS BAY	PROJECT No:		D١
		T 02 4226 3600	T 02 4421 6822	T 02 4472 7388			


CHECKED: DATE:

17-0049

MFJ 16.12.2019

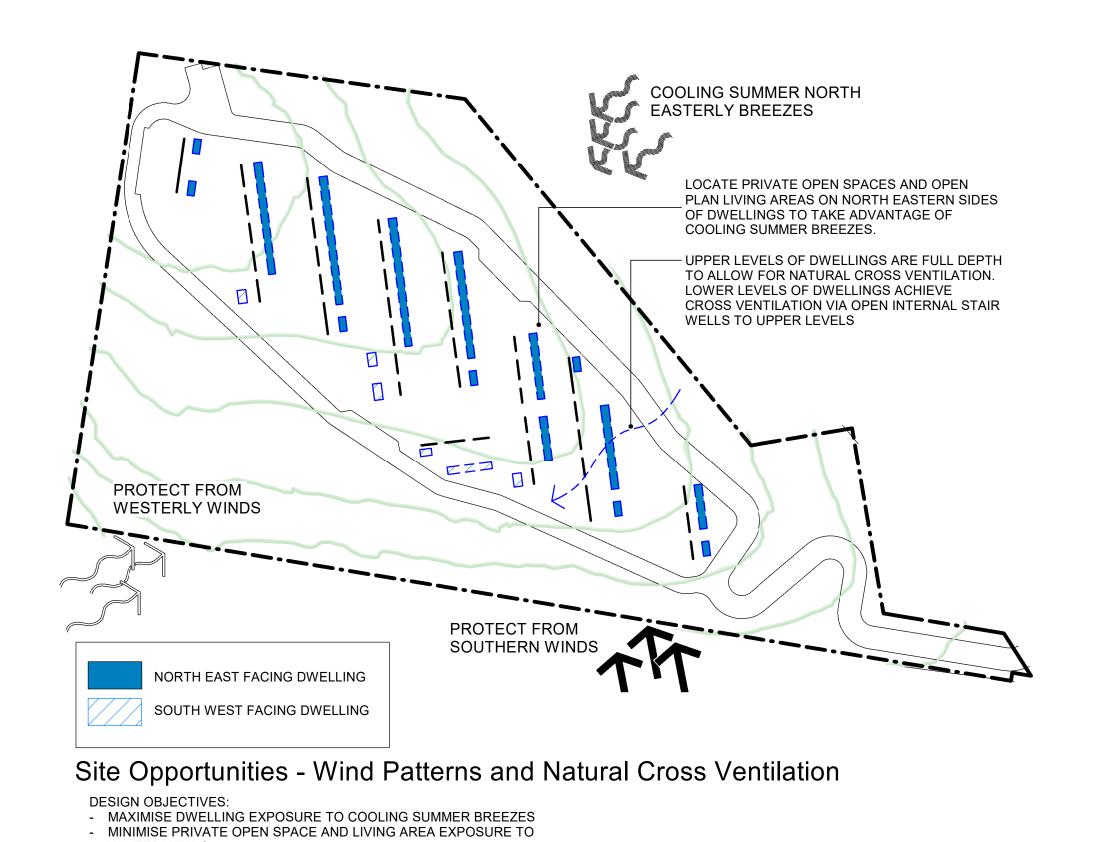


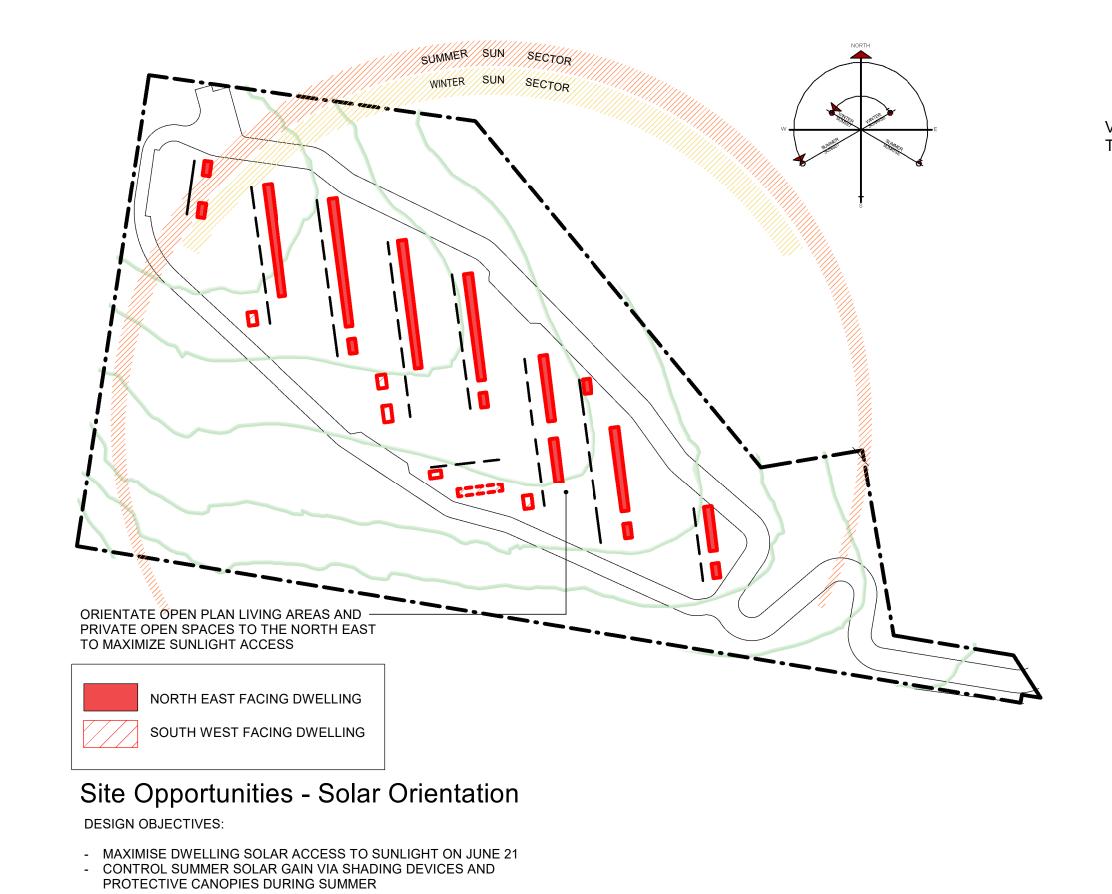


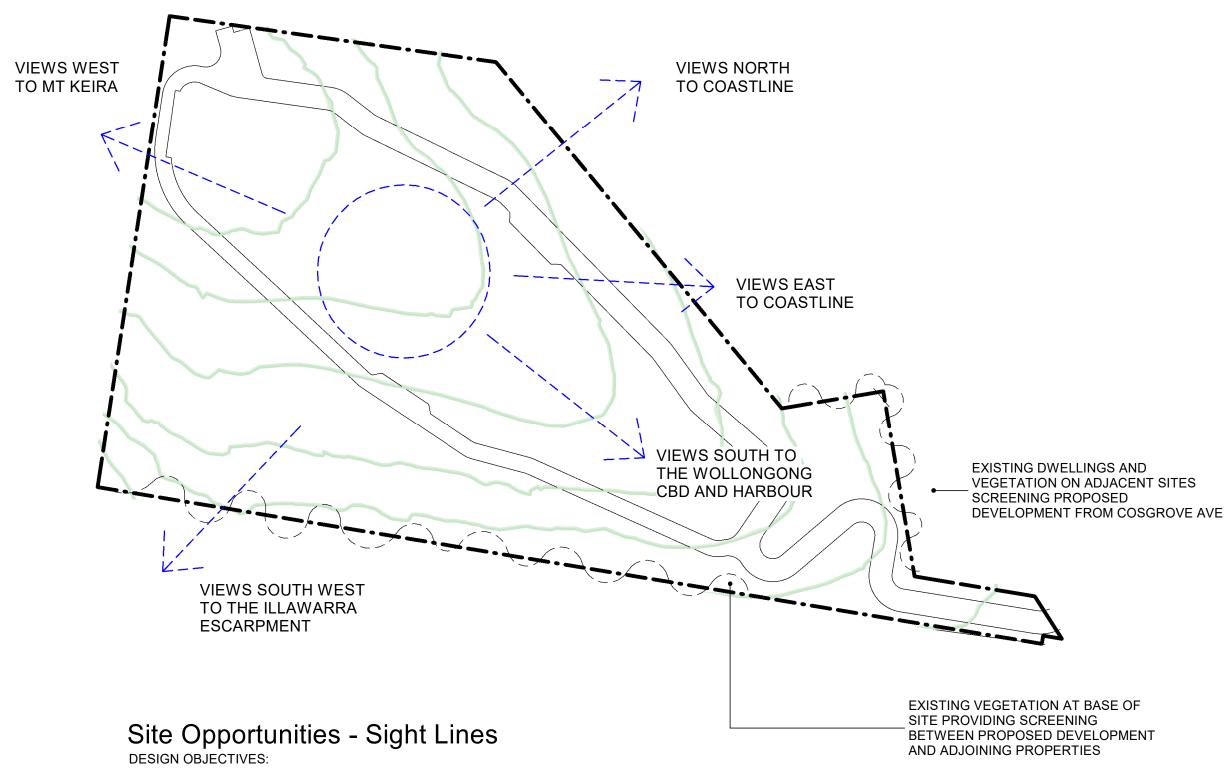

- MAXIMISE SIGHT LINES FROM THE PROPOSED DWELLINGS TO THE
- EASTERN COASTLINE AND WESTERN ESCARPMENT - DEVELOP THE SITE VEGETATION TO PROVIDE SCREENING BETWEEN THE PROPOSED DEVELOPMENT AND ADJOINING PROPERTIES



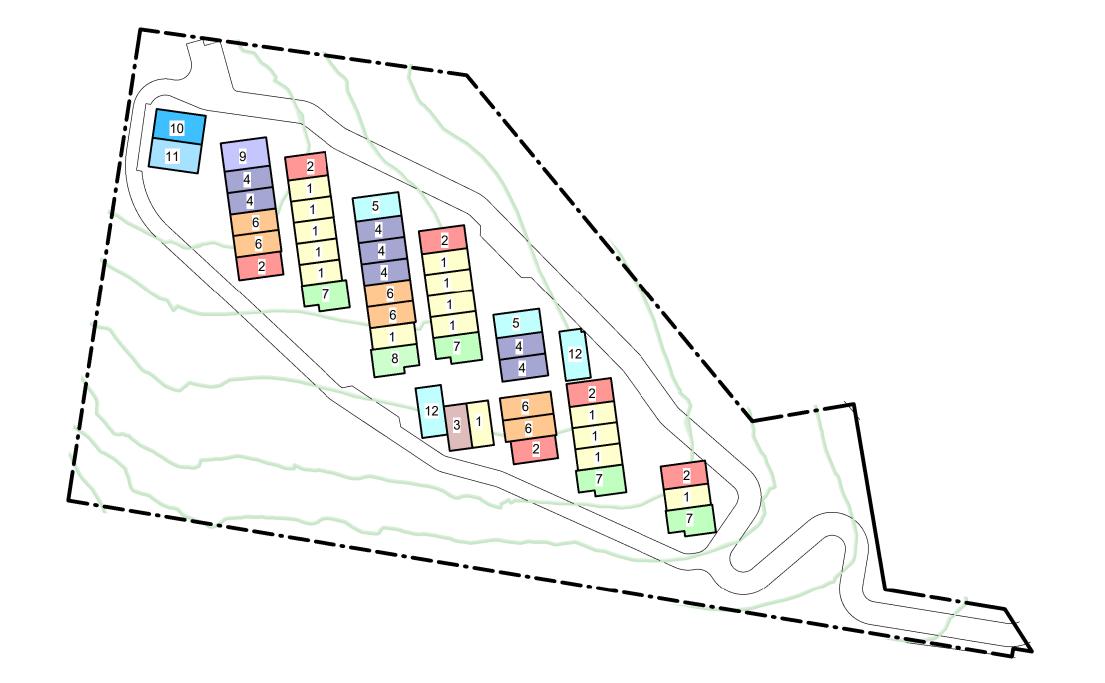

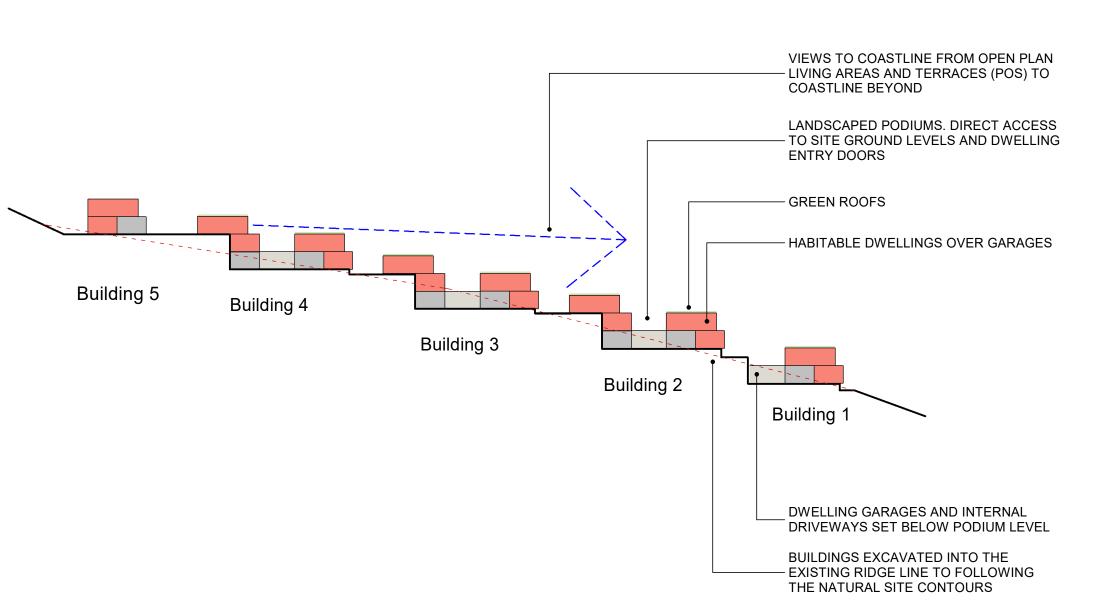

Building Location Plan

WINTER WINDS

DESIGN OBJECTIVES:

 THE MULTI DWELLING HOUSES HAVE BEEN CLUSTERED INTO FIVE BUILDINGS.
 EACH BUILDING ACTS AS A STAND ALONE FACILITY IN WHICH THE RESIDENTS HAVE DIRECT ACCESS FROM THEIR DWELLING TO THE REQUIRED FACILITIES AS OUTLINED BY THE WOLLONGONG DCP . THESE FEATURES INCLUDE, BUT NOT LIMITED

ACCESS TO EXTERNAL NATURAL GROUND LEVEL FROM DWELLING ENTRY DOORS
 COMMUNAL OPEN SPACE

 VISITOR PARKING WASTE & RECYCLING FACILITIES

 EXTERNAL CLOTHES DRYING AREAS PEDESTRIAN ACCESS BETWEEN BUILDINGS 1 TO 5

DWELLING SUMMARY Three Bedroom Dwellings 36 OFF 11 OFF Four Bedroom Dwellings TOTAL DWELLINGS 47 OFF

Dwelling Typology Location Plan

REFER TO ARCHITECTURAL DRAWINGS DA/28 AND DA/29

FOR JUNE 21 SOLAR ACCESS REVIEW

REFER TO ARCHITECTURAL DRAWINGS DA/22 & DA/23 FOR DWELLING TYPOLOGY FLOOR PLANS (SCALE 1:100)

DWELLI	NG TYPE SCH	IEDULE
Dwelling Type	Description	Quanitiy
Type 1	Three Bedroom	15
Type 2	Three Bedroom	6
Type 3	Three Bedroom	1
Type 4	Three Bedroom	7
Type 5	Three Bedroom	2
Type 6	Four Bedroom	6
Type 7	Three Bedroom	4
Type 8	Three Bedroom	1
Type 9	Four Bedroom	1
Type 10	Four Bedroom	1
Type 11	Four Bedroom	1
Type 12	Four Bedroom	2
	·	

DWELLING TYPE No	GFA m²	GARAGE m²	TERRACE m²	TOTAL m²
Type 1	180	44	38	262
Type 2	180	50	48	278
Type 3	172	58	48	278
Type 4	186	56	41	283
Type 5	193	57	44	294
Type 6	230	48	56	334
Type 7	218	50	60	328
Type 8	228	48	57	333
Type 9	219	67	42	328
Type 10	252	44	57	353
Type 11	252	44	57	353
Type 12	198	53	53	304

Concept Site Section


DESIGN OBJECTIVES:

- MAXIMISE SIGHT LINES FROM THE PROPOSED DWELLINGS TO
- THE EASTERN COASTLINE AND WESTERN ESCARPMENT - MINIMIZE THE BUILDING FORM SCALE BY SETTING THEM

DOWN INTO THE EXISTING TOPOGRAPHY


	COPYRIGHT OF TILMENT PTY LTD (ACN 003 163 451) trading as EDMISTON JONES GBB © 2019			
10:59:36 AM	THIS DRAWING ALWAYS REMAINS THE COPYRIGHT OF EDMISTON JONES GBB AND SHALL NOT BE USED OTHER THAN FOR THE PROJECT INTENDED WITHOUT WRITTEN AUTHORITY. LEVELS SHOWN ON PLAN ARE APPROXIMATE ONLY AND SHALL BE VEDICIED ON SITE BEFORE CONSTRUCTION COMMENCES.	EVISION		
16/12/2019 1	USE FIGURED DIMENSIONS IN PREFERENCE TO SCALE. VERIFY ALL DIMENSIONS ON SITE BEFORE CONSTRUCTION COMMENCES.	1	Development Application	16.12.2019
		REV	. DESCRIPTION	DATE

SITE ANALYSIS & BUILDING SUMMARY

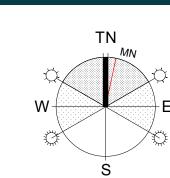

ty Ltd Proposed Residential Development THE COSGROVE At Lot 90 in D.P. 1086429, 14 Cosgrove Ave Keiraville, NSW, 2500	DRAWING TITLE: Site Analysis	Plans a
At Lot 90 in D.P. 1086429, 14 Cosgrove Avenue	SCALE: @ B1	DRAWN:
, ,	NOT TO SCALE	EJ
	Proposed Residential Development THE COSGROVE At Lot 90 in D.P. 1086429, 14 Cosgrove Avenue,	Proposed Residential Development THE COSGROVE At Lot 90 in D.P. 1086429, 14 Cosgrove Avenue, Site Analysis

.td	Proposed Residential Development THE COSGROVE			Site Analysis	Plan	s and	d Building	Sun	nmary	
		0 in D.P. 108 le, NSW, 250	•	osgrove Avenue,	SCALE: @ B1 NOT TO SCALE	DRAW E	'N: J	CHECKED: MFJ	16. ²	: 12.2019
		WOLLONGONG T 02 4226 3600	NOWRA T 02 4421 6822	BATEMANS BAY T 02 4472 7388	PROJECT No:		DWG	No:	•	ISSUE:
	_]	W www.aej.com.au	E aej@aej.com.au		17-0049		D	4/04		1
		Nominated Architect S	teven Bayer Reg. No.	5880						

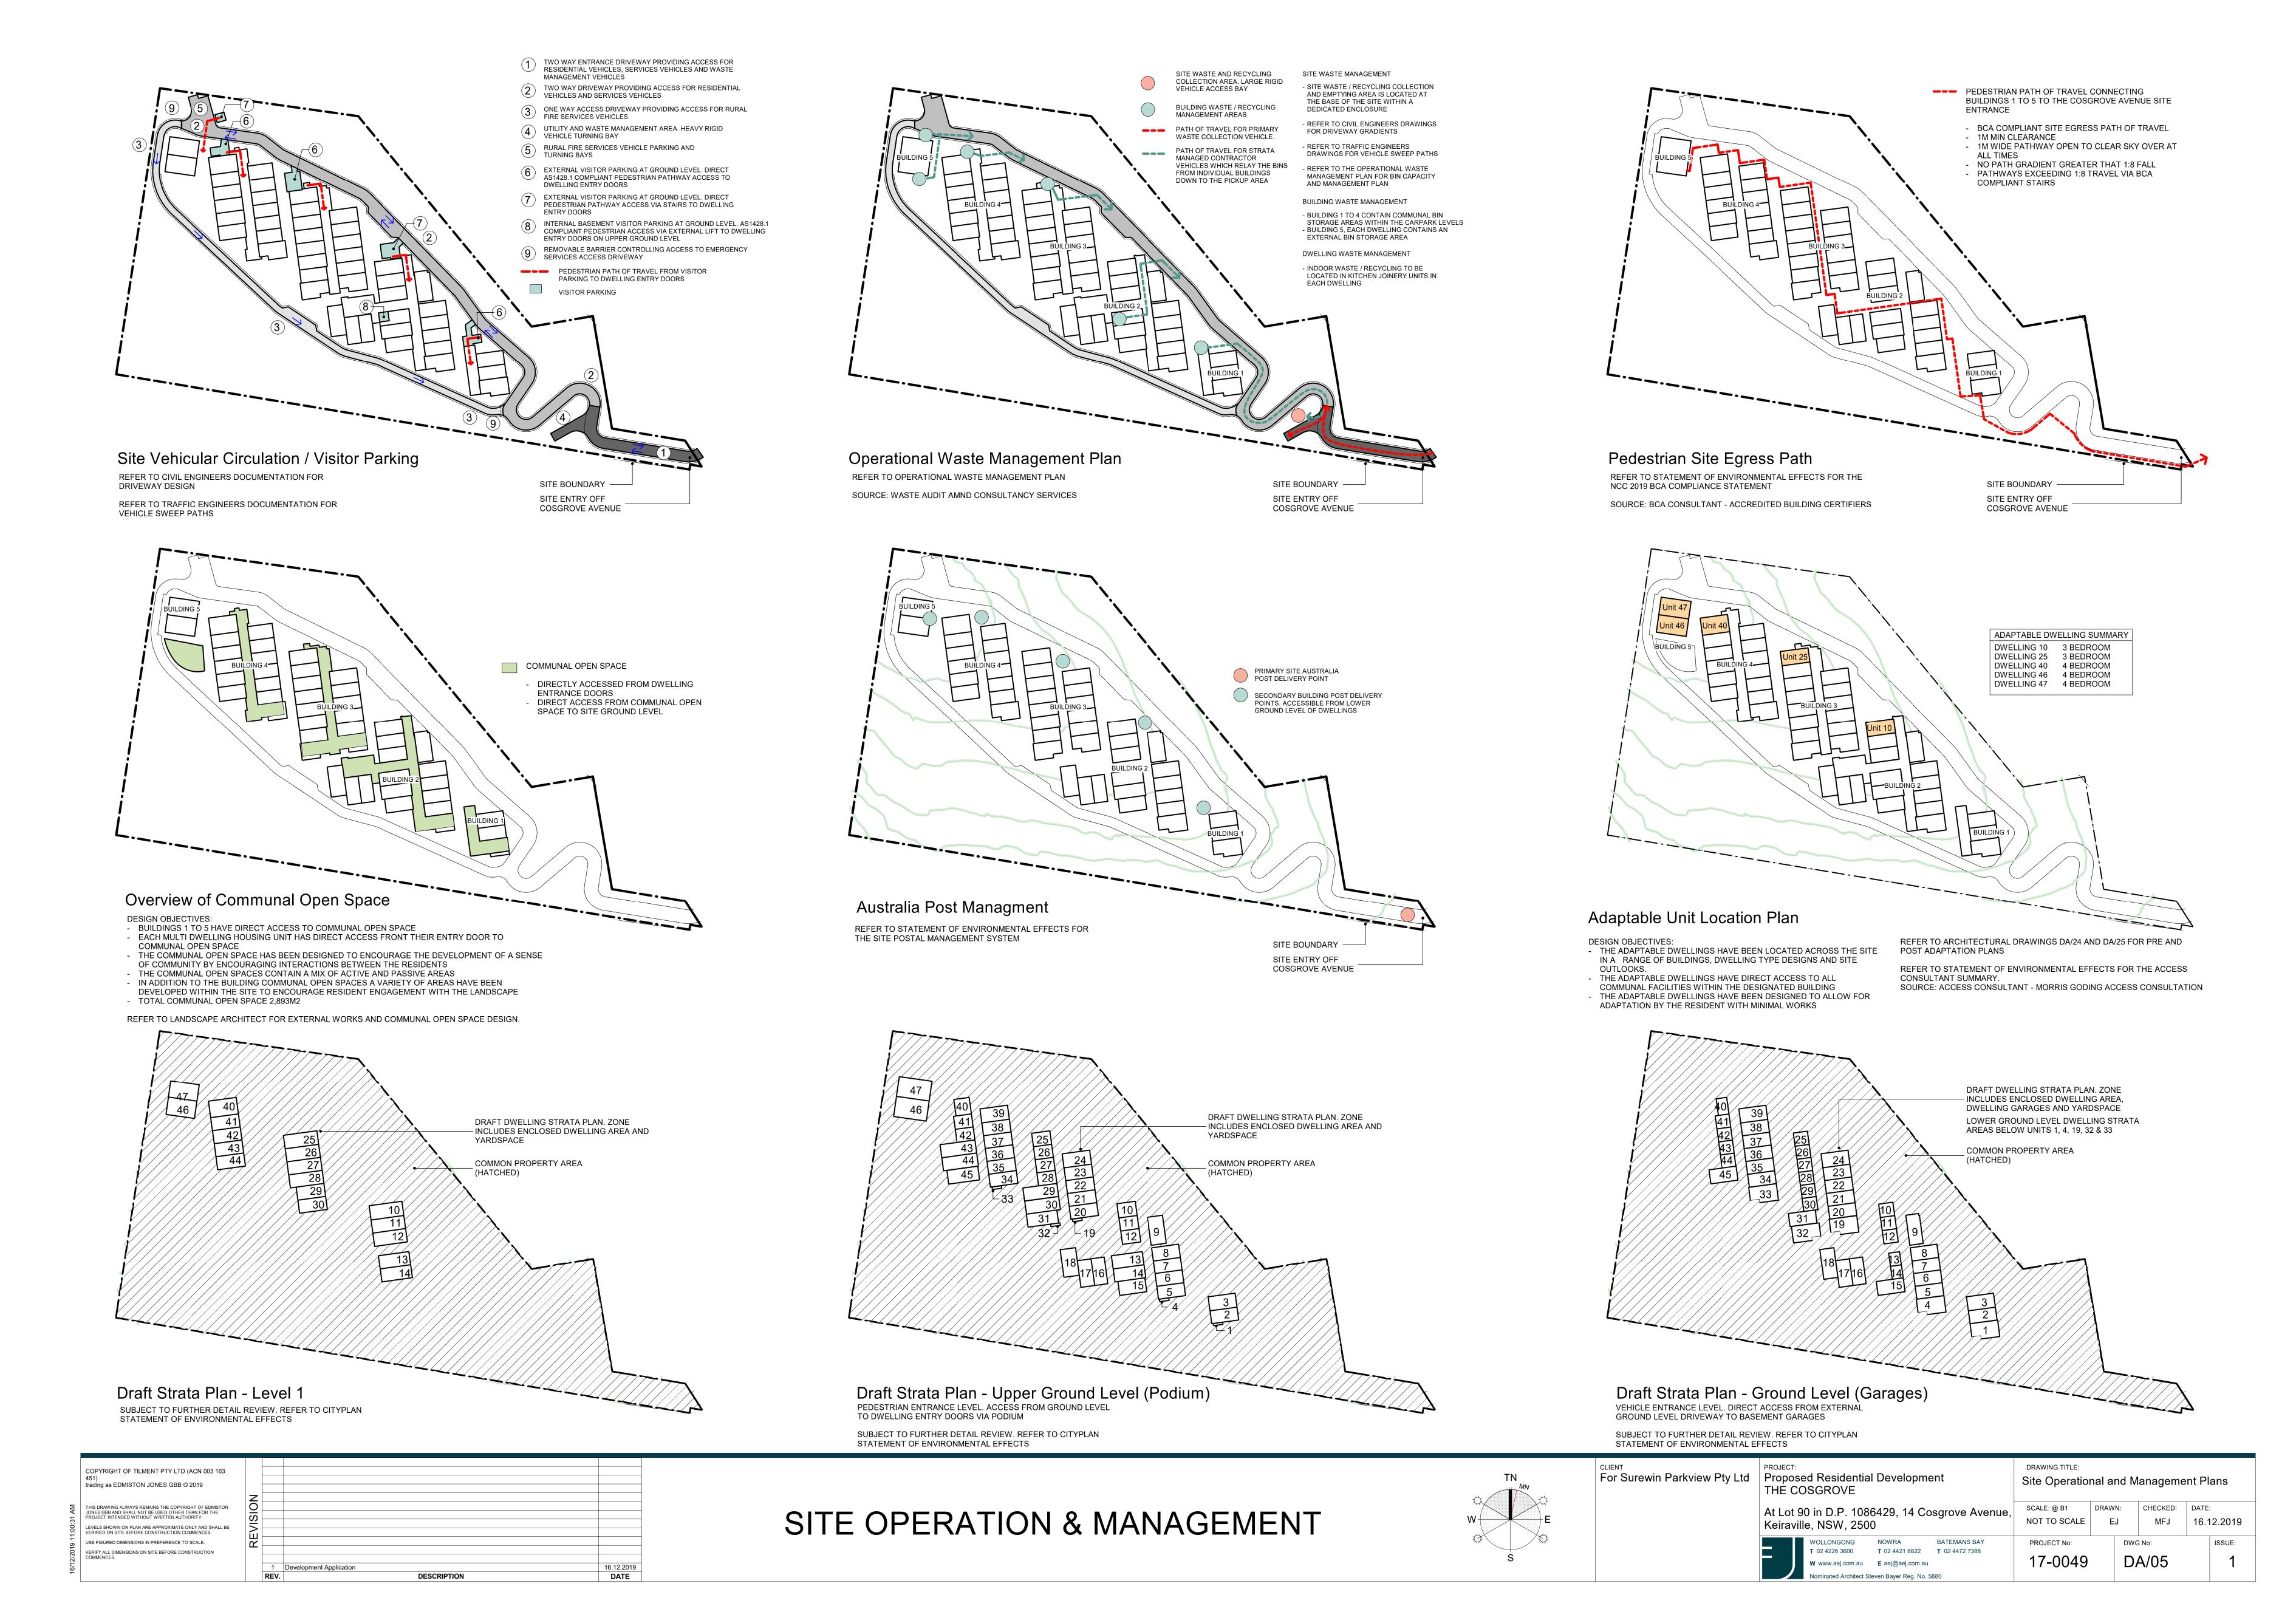



LEVELS SHOWN ON PLAN ARE APPROXIMATE ONLY AND SHALL BE VERIFIED ON SITE BEFORE CONSTRUCTION COMMENCES.

1 Development Application

DESCRIPTION

16.12.2019

DATE

USE FIGURED DIMENSIONS IN PREFERENCE TO SCALE.

VERIFY ALL DIMENSIONS ON SITE BEFORE CONSTRUCTION COMMENCES.

LEGEND

1 SITE ENTRANCE

- SITE ENTRANCE SIGNAGE - ELECTRICAL SUBSTATION - SITE SERVICES AND FIRE BOOSTER VALVE SET

- POSTAL DELIVERY 2 UTILITY AND WASTE MANAGEMENT AREA - CENTRAL WASTE MANAGEMENT AREA - LARGE VEHICLE DELIVERY DECANTING AREA

- LARGE VEHICLE TURNING BAY

ONE WAY ACCESS DRIVEWAY FOR EMERGENCY SERVICES AND MAINTENANCE VEHICLES ONLY

5 RURAL FIRE SERVICES 100,000L WATER TANK AND TURNING

6 EXTERNAL VISITOR PARKING WITH DIRECT ACCESS TO

BUILDING PODIUMS AND DWELLING ENTRANCE DOORS

7 EXTERNAL RESIDENTIAL DRIVEWAYS PROVIDING ACCESS TO INTERNAL BUILDING PARKING AISLES AND DWELLING

8 EXTERNAL RESIDENTIAL DRIVEWAY PROVIDING DIRECT ACCESS TO EXTERNAL DWELLING GARAGES

g LANDSCAPED PODIUMS OVER LOWER GROUND LEVEL -PODIUMS HAVE DIRECT ACCESS TO EXTERNAL SITE GROUND LEVEL VISITOR PARKING, PATHWAYS, LANDSCAPED AREAS AND DWELLING ENTRY DOORS

10 2 LEVEL DWELLINGS (CLASS 2). DIRECT PEDESTRIAN ACCESS FROM DWELLING ENTRANCE DOORS TO GROUND LEVEL

11 2 LEVEL DWELLINGS OVER GARAGE (CLASS 2). DIRECT PEDESTRIAN ACCESS FROM DWELLING ENTRANCE DOORS TO GROUND LEVEL

12 2 LEVEL DWELLINGS (CLASS 1a). DIRECT PEDESTRIAN ACCESS FROM DWELLING ENTRANCE DOORS TO GROUND LEVEL

13 COMMON OPEN SPACE - DIRECT PEDESTRIAN ACCESS TO DWELLING ENTRANCE

14 DRYING COURTS

- DIRECT ACCESS TO DWELLINGS (AS1428.1 COMPLIANT)

15 STORMWATER BIO-RETENTION BASIN

16 RESIDENTS ACTIVITIES AREA. REFER TO LANDSCAPE DOCUMENTATION FOR DETAILS

APZ SETBACK - ALL ENCLOSED HABITABLE DWELLING AREAS ARE WITHIN THE COMPLIANT APZ SETBACKS. GEOTECHNICAL CONSTRAINT

BOUNDARY

PROPERTY DWELLING. FOOTPRINT SOURCED FROM 'SIX MAPS' NSW LAND & PROPERTY INFORMATION A ADAPTABLE UNIT

LANDSCAPED PLANTER BED MC MOTORCYCLE PARKING POS PRIVATE OPEN SPACE YARD

SITE CONTOUR 1M INTERVAL

T TERRACE PRIVATE OPEN SPACE VP VISITOR PARKING

DCP COMPLIANCE SUMM	ARY
SITE AREA (INCLUDING E2 ZONE) SITE AREA (EXCLUDING E2 ZONE)	41,934 m ² 36,753 m ²
PROPOSED GFA (EXCLUDING PODIUMS) PROPOSED GFA (INCLUDING PODIUMS)	9,322 m² 11,887 m²
ALLOWABLE FSR RATIO PROPOSED FSR (EXCLUDING E2 ZONE) PROPOSED FSR (INCLUDING E2 ZONE) (PROPOSED FSR RATIO INCLUDES THE POI	0.50 : 1 0.32 : 1 0.28 : 1 DIUM AREAS)
REQUIRED TOTAL LANDSCAPED AREA (30% OF SITE. EXCLUDING E2 ZONE) PROPOSED TOTAL LANDSCAPED AREA (EXCLUDING E2 ZONE)	11,026 m ² 21,209 m ²
REQUIRED DEEP SOIL ZONE AREA (15% OF SITE OR REAR AT 6m) PROPOSED DEEP SOIL ZONE AREA (EXCLUDING E2 ZONE)	5,513 m ² 15,370 m ²
REQUIRED COMMUNAL OPEN SPACE (5 m² PER DWELLING) PROPOSED COMMUNAL OPEN SPACE	235 m ² 2,893 m ²
DWELLING STORAGE COMPLIANCE: DWELLINGS WITH 3 OR MORE BEDROOMS MINIMUM STORAGE ALLOWANCE OF - 10m³	

THE ARCHITECTURAL SITE PLAN IS TO BE READ IN CONJUNCTION WITH THE FOLLOWING DOCUMENTS;

REFER TO THE LANDSCAPE ARCHITECTS DOCUMENTATION FOR THE PROPOSED EXISTING TREE REMOVAL, EXISTING TREE RETENTION, PROPOSED NEW PLANTING, RETAINING WALL LOCATIONS AND HEIGHTS, PATHWAY LOCATIONS AND HEIGHTS, FINISHED GROUND

REFER TO DRAWINGS DA/07 TO DA/20 FOR 1:200 BUILDING PLANS AND ELEVATIONS

REFER TO DRAWINGS DA/22 & DA/23 FOR 1:100 DWELLING TYPOLOGY PLANS

REFER TO THE CIVIL ENGINEERS DOCUMENTATION FOR

REFER TO THE STATEMENT OF ENVIRONMENTAL EFFECTS FOR THE ASSOCIATED REPORTED IN RELATION

TO SITE MANAGEMENT. INCLUDING BUT NOT LIMITED TO;

TRAFFIC(PARKING & VEHICLE SWEEP PATHS)


 WASTE MANAGEMENT ACCESSIBILITY

 BUSHFIRE CONTROL AND MAINTENANCE AUSTRALIA POST MANAGEMENT SYSTEM

DRAWING TITLE:

Keiraville, NSW, 2500 VOLLONGONG T 02 4226 3600 T 02 4421 6822 T 02 4472 7388 **W** www.aej.com.au **E** aej@aej.com.au

Proposed Site Plan & Roof Plan CHECKED: DATE: DRAWN: MFJ 16.12.2019 EJ PROJECT No: ISSUE: 17-0049

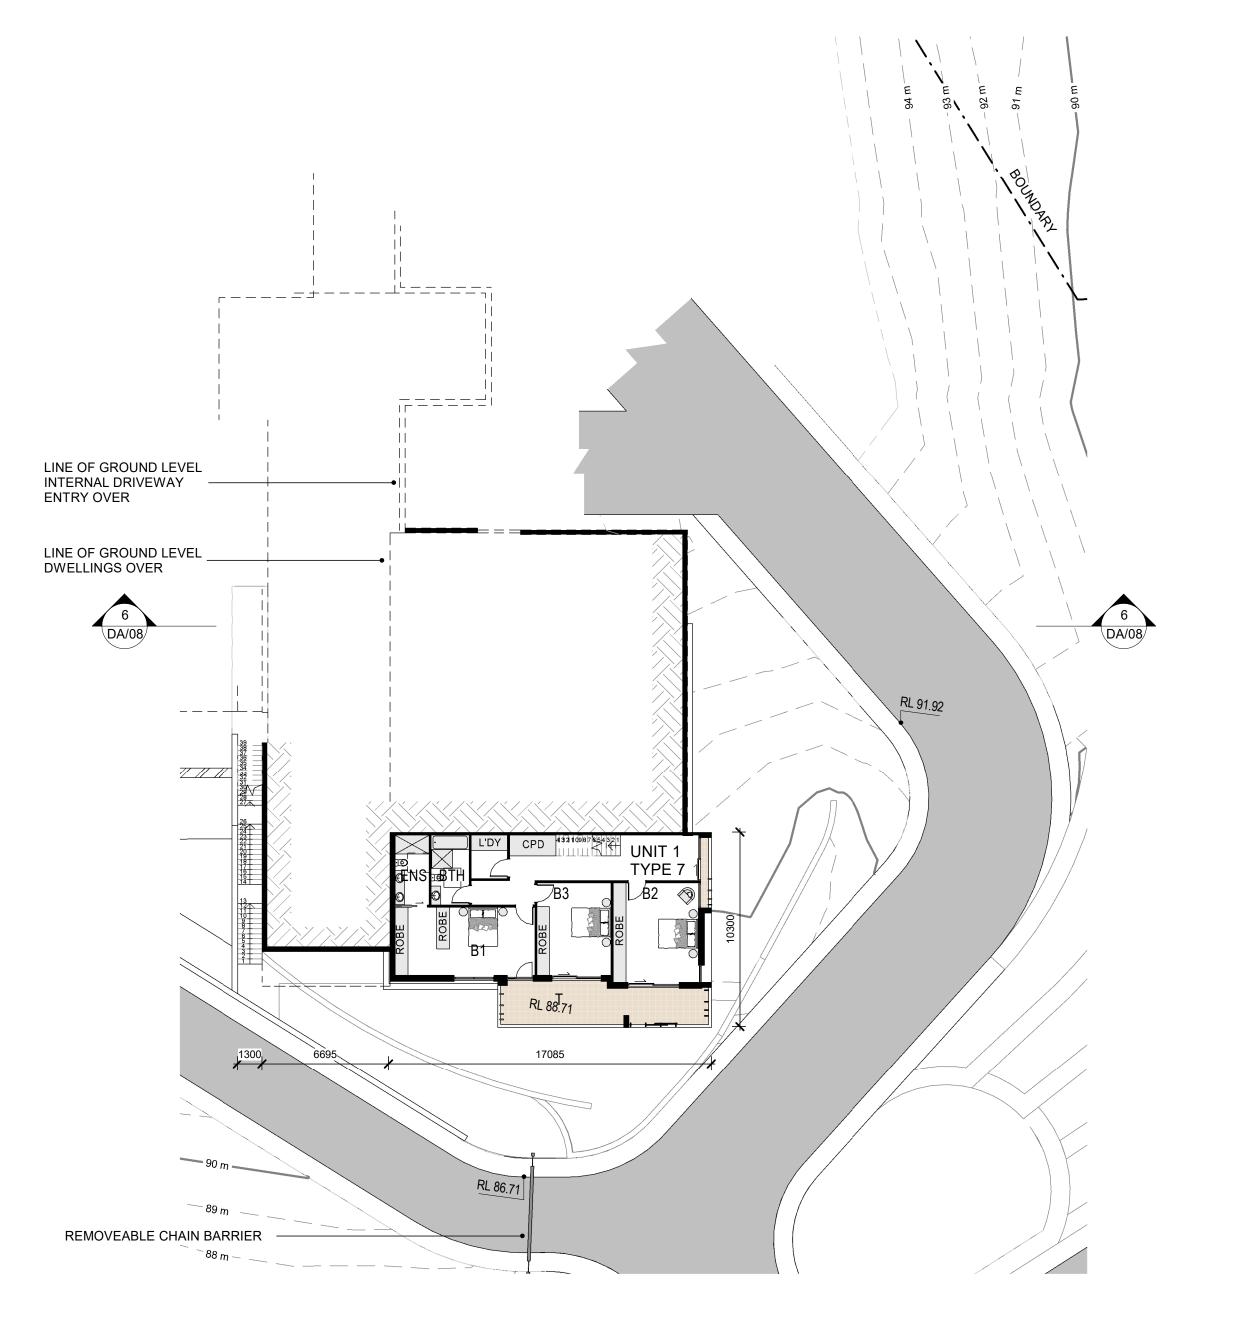


WASTE STORAGE - VEHICLE ACCESS TO DWELLING GARAGES ENCLOSED VEHICLE ACCESS AISLE TO DWELLING GARAGES PODIUM OVER COURT PEDESTRIAN ACCESS
PATHWAY FROM
COSGROVE AVE UP TO

VEHICLE ACCESS DRIVEWAY TO VISITOR PARKING AT PODIUM LEVEL STAIR ACCESS TO BUILDING 2 -/BUILDING/2/ PARKING RL 100.45 L1 114.10 UGL 110.80 GL 107.50 LGL 104.05 RL 100.60 8060 13540 LANDSCAPED PODIUM - LANDSCAPED DRIVEWAY VERGE 1M WIDE DRYING COURT, SCREENED DWELLING 1 ENTRANCE LANDSCAPED PODIUM DOOR AT PODIUM LEVEL PEDESTRIAN ACCESS —— STAIRS DOWN TO LOWER UNIT 1 TYPE 7 OPERABLE LOUVRES TO DWELLING TERRACE BELOW

Building 1 - Ground Level (Garages)

LANDSCAPE 9 DA/08 SECURE VISITOR BICYCLE PARKING - PARKING BAY FOR SERVICES CONTRACTORS PARKING BAY FOR SERVICES RL 74.31 UNDERCOVER BIN WASH BAY VERTICAL PLANTER SCREEN TO UTILITY AREA LINE OF ROOF OVER UTILITY AREA LARGE VEHICLE TURNING BAY RL 73.80 OPEN AREA ADJACENT TO WASTE — VEHICLE PARKING FOR BIN LIFTING / DECANTING RETAINING WALLS BOUNDING UTILITY AREA

Building 1 - Upper Ground Level (Podium)

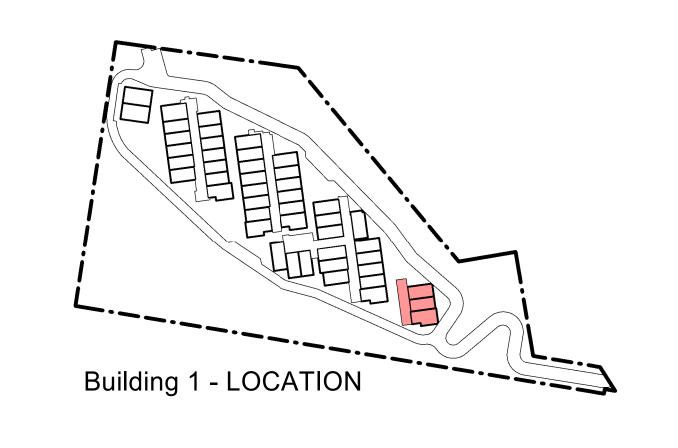

Dwelling	Dwelling	Area	Area
No	Type	Description	Totals
Bldg 1			
Unit 1	Type 7	Floor Area	224 m²
Unit 1	Type 7	Garage	49 m²
Unit 1	Type 7	Terraces	61 m²
Unit 2	Type 1	Floor Area	174 m²
	I	0	= 4 ^
Unit 2	Type 1	Garage	54 m²
Unit 2 Unit 2	Type 1 Type 1	Terraces	54 m ² 39 m ²
			39 m² 267 m²
Unit 2	Type 1	Terraces	39 m²

NOTES

THE BUILDING FLOOR PLANS ARE TO BE READ IN CONJUNCTION WITH THE FOLLOWING DOCUMENTS; REFER TO DRAWINGS DA/22 & DA/23 FOR THE 1:100 DWELLING TYPOLOGY PLANS (ROOM SIZES & FINISHES)

REFER TO THE LANDSCAPE ARCHITECTS DOCUMENTATION FOR THE PROPOSED EXTERNAL SOFT AND HARD LANDSCAPE WORKS (FINISHES AND LEVELS) REFER TO THE CIVIL ENGINEERS DOCUMENTATION FOR

	DOCUME	O LANDSCAPE ENTATION FOR PODIUM APE DESIGN
	BEDROC	NG PRIVACY CONTROL TO MS WINDOWS ADJACENT TO RIAN AREAS:
	OF BE - VERT CLIME - SLIDII	ED PLANTER BEDS IN FRONT EDROOM WINDOWS ICAL FIXED BATTENS WITH BING PLANTS NG EXTERNAL SCREENS TO OOM WINDOWS
	LEGE	ND - ROOMS
DΝ	ENT G K L LDY T WIR	BEDROOM BATH DINING ENSUITE ENTRY GARAGE KITCHEN LIVING LAUNDRY TERRACE (POS) WALK IN ROBE PRIVATE OPEN SPACE YARD REDUCE LEVEL (AHD)


LEGEND - PRIVACY

COPYRIGHT OF TILMENT PTY LTD (ACN 003 163 trading as EDMISTON JONES GBB © 2019 LEVELS SHOWN ON PLAN ARE APPROXIMATE ONLY AND SHALL BE VERIFIED ON SITE BEFORE CONSTRUCTION COMMENCES. USE FIGURED DIMENSIONS IN PREFERENCE TO SCALE. VERIFY ALL DIMENSIONS ON SITE BEFORE CONSTRUCTION COMMENCES. 16.12.2019 1 Development Application DESCRIPTION DATE

Utility and Waste Management Area

Building 1 - Lower Ground Level (Below Garage Level)


BUILDING 1 & UTILITIES AREA

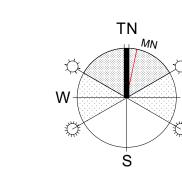


For Surewin Parkview Pty Ltd Proposed Residential Development THE COSGROVE Keiraville, NSW, 2500


At Lot 90 in D.P. 1086429, 14 Cosgrove Avenue, T 02 4226 3600 T 02 4421 6822 T 02 4472 7388 **W** www.aej.com.au **E** aej@aej.com.au

DRAWING TITLE: Building 1 & Utilities Management Area Floor Plans CHECKED: DATE: MFJ 16.12.2019 PROJECT No: DA/07 17-0049

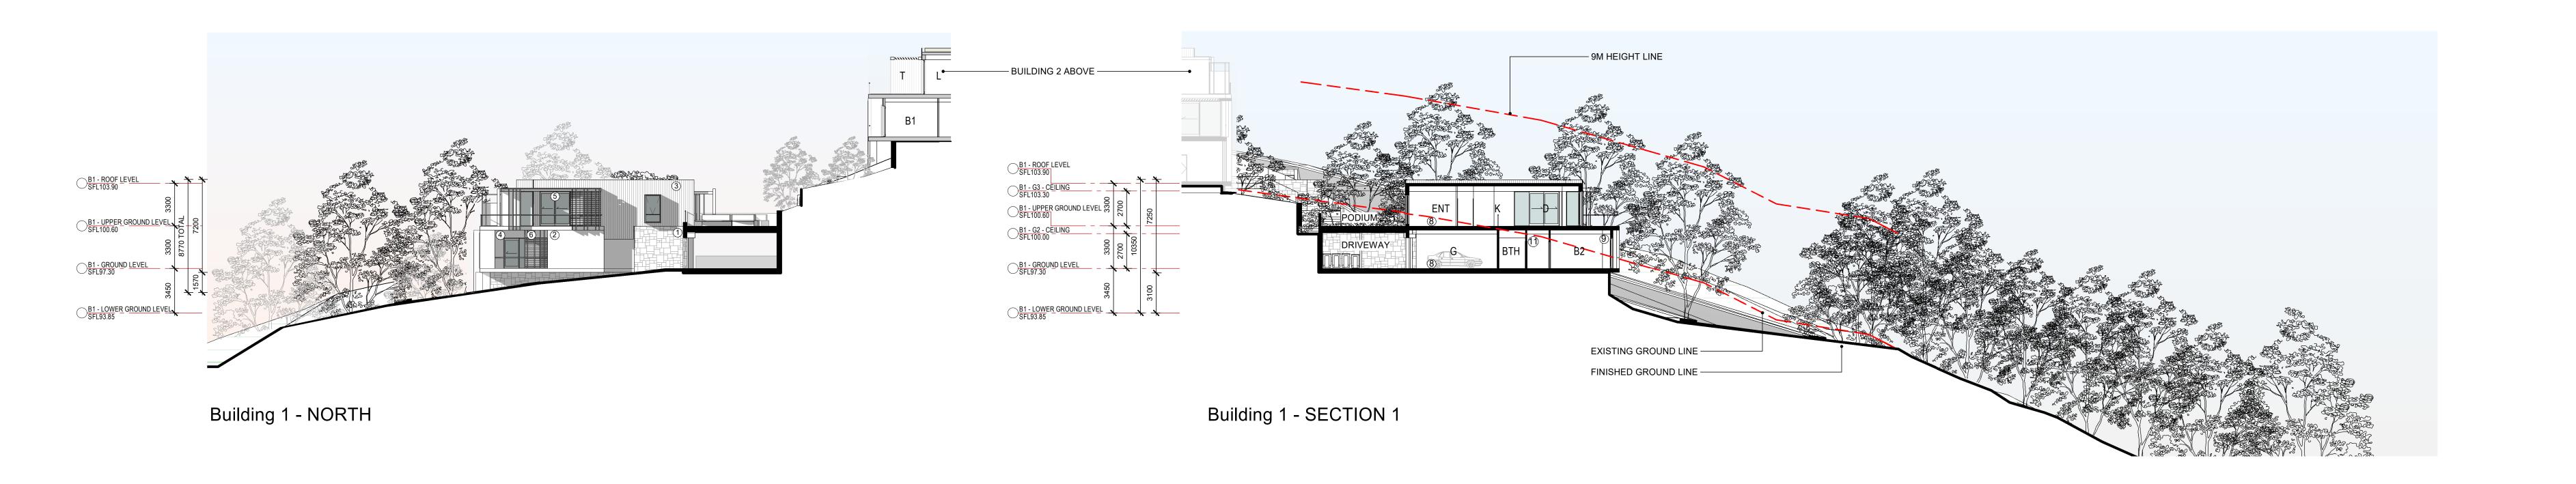

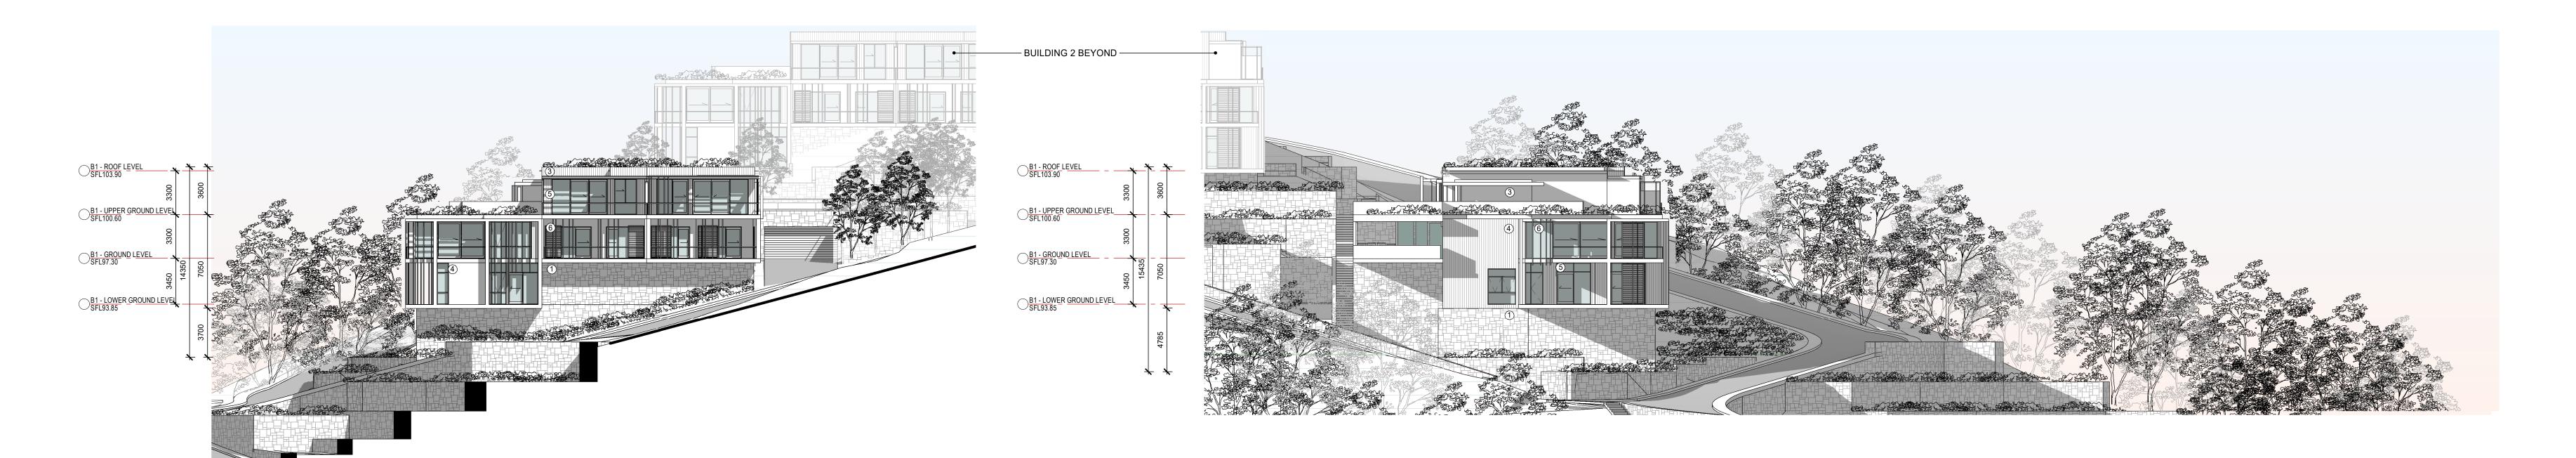

Building 1 - EAST
Building 1 - SOUTH

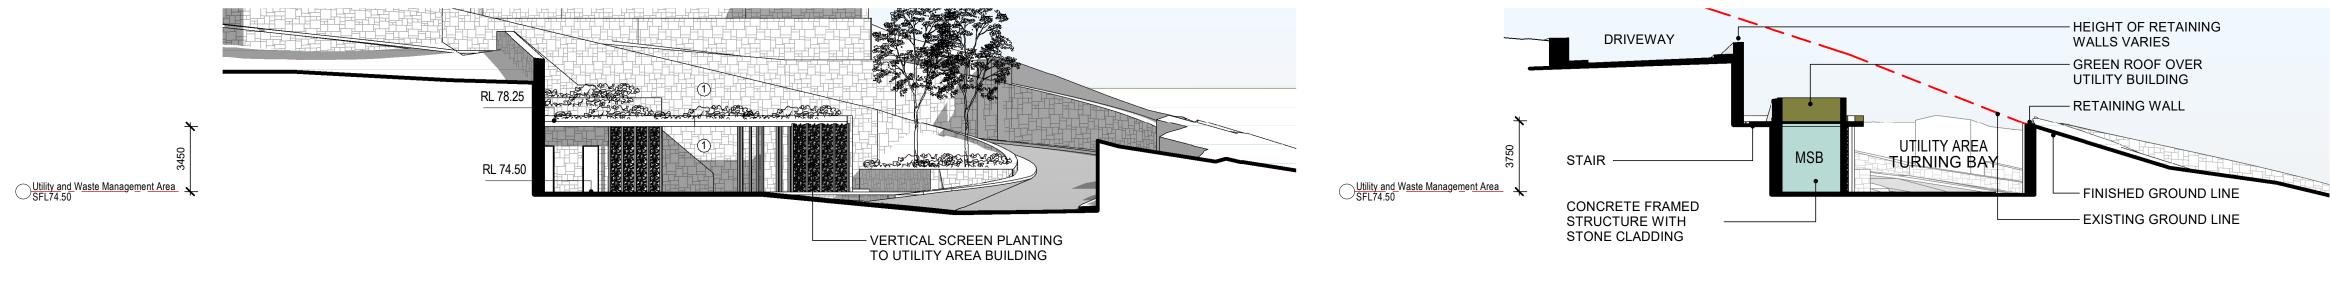

Utility & Waste Management Area - SOUTH

Utility & Waste Management Area SECTION

	LEGEND - MATERIALS	S & R	OOM TYPES
	MATERIAL TYPE	ROOM	TYPE
① ② ③ ③ ④ ⑤ ⑥ ⑦ ⑧	STONE CLADDING EXPRESSED INSITU CONCRETE FRAME LINEAL CLADDING SYSTEM, EXPRESSED JOINTS (PAINTED FIBRE CEMENT) SHEET CLADDING SYSTEM, SET JOINTS (PAINTED FIBRE CEMENT) ALUMINUM FRAMED WINDOWS (POWDER COATED FINISH) ALUMINIUM FRAMED PRIVACY SLIDING SCREENS AND FIXED BLADES (POWDERCOAT FINISH) FACE BLOCKWORK CONCRETE FRAME FLOOR STRUCTURE	B BTH D ENS ENT G K L LDY T WIR POS	BEDROOM BATH DINING ENSUITE ENTRY GARAGE KITCHEN LIVING LAUNDRY TERRACE (POS) WALK IN ROBE PRIVATE OPEN SPACE YARD
9	CONCRETE FRAME WALL STRUCTURE WITH LIGHT WEIGHT STUD INFILL FRAMES		
① ①	CONCRETE ROOF STRUCTURE (GREEN ROOF OVER) PLASTERBOARD WALL & CEILING LINING		

NOTES

17-0049

DA/08


- REFER TO DRAWING DA/30 FOR EXTERNAL BUILDING MATERIALS AND COLOURS.
- DEED TO LANDSCADE ADOLITECTS DOCUMENTA
- REFER TO LANDSCAPE ARCHITECTS DOCUMENTATION FOR THE PROPOSED PLANTING. THE FULL EXTENT OF PLANTING HAS NOT BEEN SHOWN ON THE ARCHITECTURAL ELEVATIONS FOR BUILDING CLARITY.

	COPYRIGHT OF TILMENT PTY LTD (ACN 003 163 451) trading as EDMISTON JONES GBB © 2019					
19 11:06:51 AM	THIS DRAWING ALWAYS REMAINS THE COPYRIGHT OF EDMISTON JONES GBB AND SHALL NOT BE USED OTHER THAN FOR THE PROJECT INTENDED WITHOUT WRITTEN AUTHORITY. LEVELS SHOWN ON PLAN ARE APPROXIMATE ONLY AND SHALL BE VERIFIED ON SITE BEFORE CONSTRUCTION COMMENCES. USE FIGURED DIMENSIONS IN PREFERENCE TO SCALE.	REVISION				
6/12/201	VERIFY ALL DIMENSIONS ON SITE BEFORE CONSTRUCTION COMMENCES.		1	Development Application	1	16.12.2019
7		R	REV.	DESCRIPTION		DATE

BUILDING 1 & UTILITIES AREA

		1,	0 1 2 3 4 5	6 7 8 9	10 11 12 13	14 15 16 17 18 19				
	For Surewin Parkview Pty Ltd	PROJECT: Proposed Residential Development THE COSGROVE	Building 1 & Utility Area – Elevations & Sections							
		At Lot 90 in D.P. 1086429, 14 Cosgrove Avenue, Keiraville, NSW, 2500	SCALE: @ B1 1:200	DRAWN: CHECKED: EJ MFJ		DATE: 16.12.2019				
		WOLLONGONG NOWRA BATEMANS BAY	DDO IFOT No.	DW	C Na.	ICCLIE.				

T 02 4421 6822 T 02 4472 7388

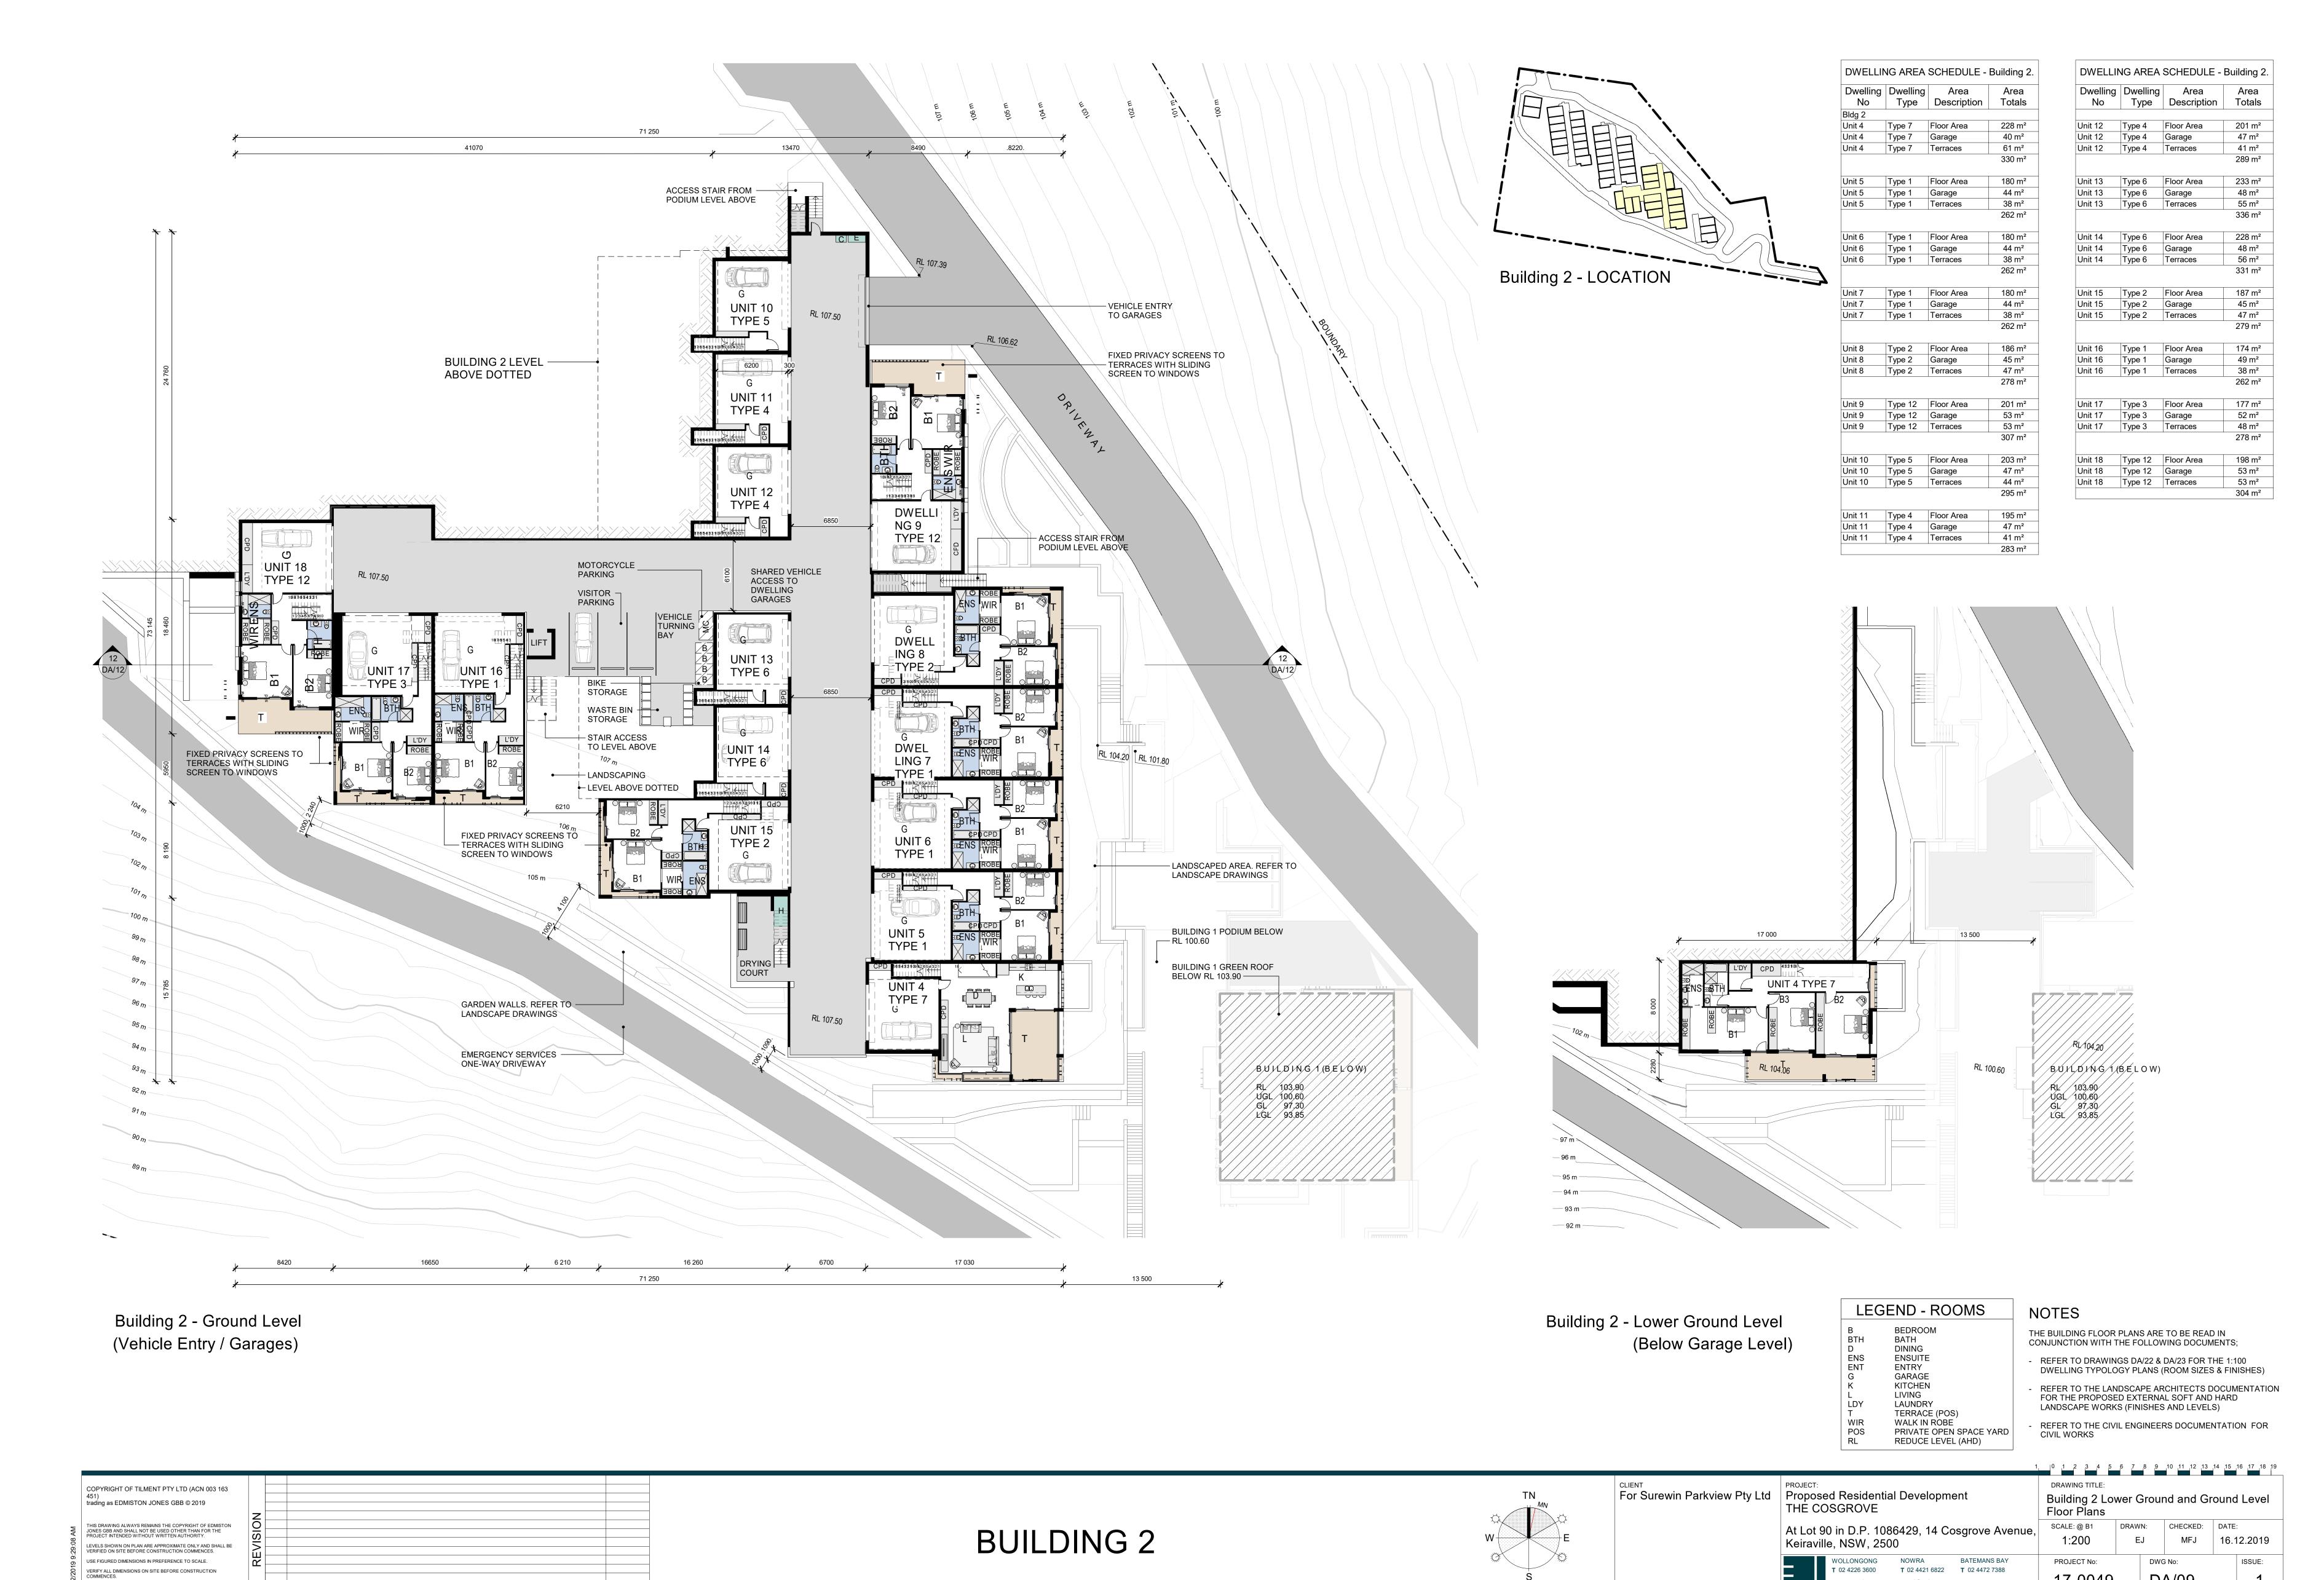

16.12.2019

DATE

Development Application

DESCRIPTION

17-0049

W www.aej.com.au **E** aej@aej.com.au



Unit 18 Type 12 Terraces Building 2 - LOCATION NOTES THE BUILDING FLOOR PLANS ARE TO BE READ IN CONJUNCTION WITH THE FOLLOWING DOCUMENTS; REFER TO DRAWINGS DA/22 & DA/23 FOR THE 1:100 DWELLING TYPOLOGY PLANS (ROOM SIZES & FINISHES) REFER TO THE LANDSCAPE ARCHITECTS DOCUMENTATION FOR THE PROPOSED EXTERNAL SOFT AND HARD LANDSCAPE WORKS (FINISHES AND LEVELS) WIR POS RL

DWELLING AREA SCHEDULE - Building 2.

Type Description

Garage

228 m² 40 m²

61 m² 330 m²

180 m²

44 m²

38 m² 262 m²

180 m² 44 m² 38 m² 262 m²

180 m² 44 m²

38 m²

262 m²

45 m²

47 m² 278 m²

201 m² 53 m²

53 m²

203 m²

47 m² 44 m²

295 m²

195 m²

47 m²

41 m²

283 m²

201 m²

47 m²

41 m²

289 m²

233 m²

48 m²

55 m² 336 m²

228 m²

48 m²

56 m²

187 m²

45 m²

279 m²

174 m²

49 m² 38 m²

177 m²

52 m² 48 m²

198 m²

53 m² 53 m²

Type 7 Floor Area

Type 7 Terraces

Type 1 Floor Area

Type 1 Garage

Type 1 Floor Area
Type 1 Garage
Type 1 Terraces

Type 1 Floor Area
Type 1 Garage

Type 1 Terraces

Type 2 Garage

Type 12 Floor Area
Type 12 Garage

Unit 8 Type 2 Terraces

Unit 9 Type 12 Terraces

Unit 10 Type 5 Floor Area

Unit 10 Type 5 Garage

Unit 10 Type 5 Terraces

Unit 11 Type 4 Terraces

Unit 12 Type 4 Floor Area
Unit 12 Type 4 Garage

Unit 12 Type 4 Terraces

Unit 13 Type 6 Floor Area

Unit 13 Type 6 Terraces

Unit 14 Type 6 Floor Area

Unit 14 Type 6 Garage

Unit 14 Type 6 Terraces

Unit 15 Type 2 Floor Area

Unit 15 Type 2 Garage

Unit 15 Type 2 Terraces

Unit 16 Type 1 Floor Area

Unit 16 Type 1 Garage
Unit 16 Type 1 Terraces

Unit 17 Type 3 Garage
Unit 17 Type 3 Terraces

Unit 18 Type 12 Floor Area

Unit 18 Type 12 Garage

Type 3 Floor Area

Unit 13 Type 6 Garage

Type 4 Garage

Dwelling Dwelling Area

Type 7

Unit 5 Type 1 Terraces

Unit 4

Unit 8

REFER TO LANDSCAPE
DOCUMENTATION FOR PODIUM
LANDSCAPE DESIGN

- **9** DWELLING PRIVACY CONTROL TO BEDROOMS WINDOWS ADJACENT TO PEDESTRIAN AREAS:
- RAISED PLANTER BEDS IN FRONT OF BEDROOM WINDOWS VERTICAL FIXED BATTENS WITH CLIMBING PLANTS SLIDING EXTERNAL SCREENS TO

LEGEND - PRIVACY

LEGEND - ROOMS

BEDROOM WINDOWS

BEDROOM BATH DINING **ENSUITE ENTRY** GARAGE KITCHEN LIVING LAUNDRY TERRACE (POS)

WALK IN ROBE


PRIVATE OPEN SPACE YARD

REDUCE LEVEL (AHD)

REFER TO THE CIVIL ENGINEERS DOCUMENTATION FOR

COPYRIGHT OF TILMENT PTY LTD (ACN 003 163 trading as EDMISTON JONES GBB © 2019 THIS DRAWING ALWAYS REMAINS THE COPYRIGHT OF EDMISTON JONES GBB AND SHALL NOT BE USED OTHER THAN FOR THE PROJECT INTENDED WITHOUT WRITTEN AUTHORITY. LEVELS SHOWN ON PLAN ARE APPROXIMATE ONLY AND SHALL BE VERIFIED ON SITE BEFORE CONSTRUCTION COMMENCES. USE FIGURED DIMENSIONS IN PREFERENCE TO SCALE. VERIFY ALL DIMENSIONS ON SITE BEFORE CONSTRUCTION COMMENCES. 16.12.2019 1 Development Application DESCRIPTION DATE

BUILDING 2

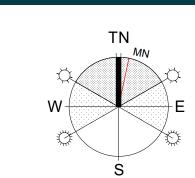

For Surewin Parkview Pty Ltd | Proposed Residential Development THE COSGROVE


At Lot 90 in D.P. 1086429, 14 Cosgrove Avenue, Keiraville, NSW, 2500


T 02 4226 3600 T 02 4421 6822 T 02 4472 7388 **W** www.aej.com.au **E** aej@aej.com.au

DRAWING TITLE: Building 2 Upper Ground Floor Plan DRAWN:

CHECKED: DATE: MFJ 16.12.2019 PROJECT No: ISSUE: 17-0049



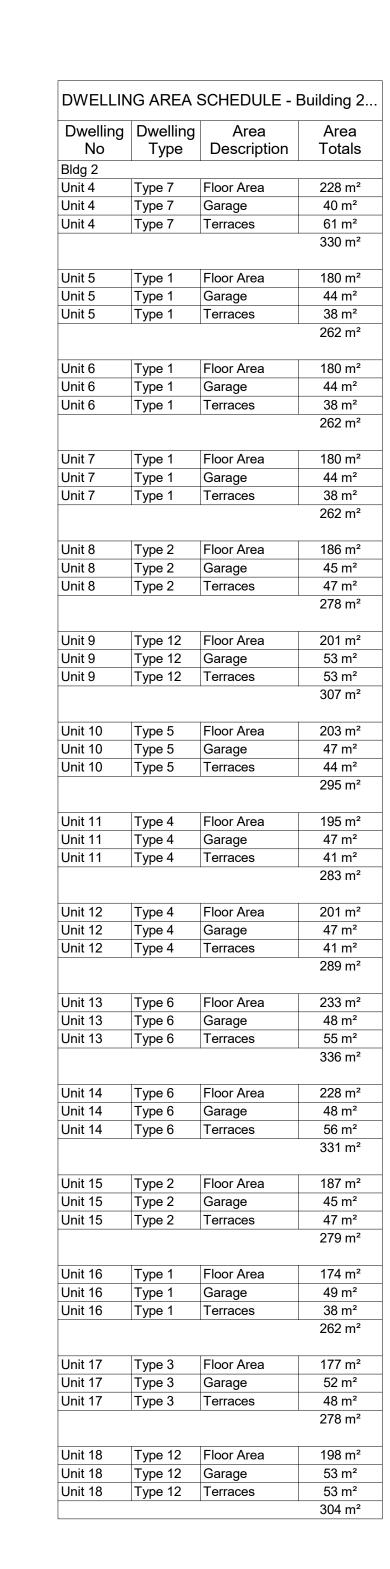

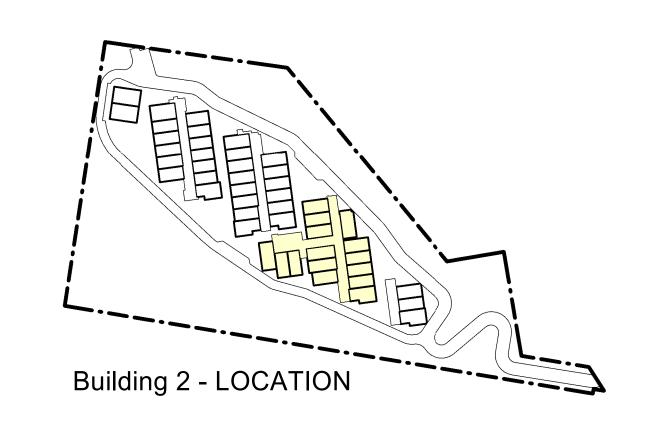

LEGEND - ROOMS

	JEND - NOOMS	
B BTH D ENS ENT G K L	BEDROOM BATH DINING ENSUITE ENTRY GARAGE KITCHEN LIVING LAUNDRY	
T .	TERRACE (POS)	
WIR POS RL	WALK IN ROBE PRIVATE OPEN SPACE YARD REDUCE LEVEL (AHD)	

THE BUILDING FLOOR PLANS ARE TO BE READ IN CONJUNCTION WITH THE FOLLOWING DOCUMENTS;


REFER TO DRAWINGS DA/22 & DA/23 FOR THE 1:100 DWELLING TYPOLOGY PLANS (ROOM SIZES & FINISHES)

REFER TO THE LANDSCAPE ARCHITECTS DOCUMENTATION FOR THE PROPOSED EXTERNAL SOFT AND HARD LANDSCAPE WORKS (FINISHES AND LEVELS)

REFER TO THE CIVIL ENGINEERS DOCUMENTATION FOR CIVIL WORKS

COPYRIGHT OF TILMENT PTY LTD (ACN 003 163 trading as EDMISTON JONES GBB © 2019 THIS DRAWING ALWAYS REMAINS THE COPYRIGHT OF EDMISTON JONES GBB AND SHALL NOT BE USED OTHER THAN FOR THE PROJECT INTENDED WITHOUT WRITTEN AUTHORITY. LEVELS SHOWN ON PLAN ARE APPROXIMATE ONLY AND SHALL BE VERIFIED ON SITE BEFORE CONSTRUCTION COMMENCES. USE FIGURED DIMENSIONS IN PREFERENCE TO SCALE. VERIFY ALL DIMENSIONS ON SITE BEFORE CONSTRUCTION COMMENCES. 16.12.2019 1 Development Application DESCRIPTION DATE

BUILDING 2

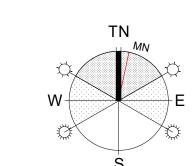

For Surewin Parkview Pty L

PROJECT: Proposed Residential Development THE COSGROVE
At Lot 90 in D.P. 1086429, 14 Cosgrove A


E CC	SGROVE		
	0 in D.P. 108 le, NSW, 250	-	Cosgrove Ave
	WOLLONGONG	NOWRA	BATEMANS BAY


o in D.P. 1086429, 14 Cosgrove Avenue, e, NSW, 2500					
WOLLONGONG	NOWRA	BATEMANS BAY	PRO		
T 02 4226 3600	T 02 4421 6822	T 02 4472 7388	17		
W www.aej.com.au	E aej@aej.com.au		1/		

DRAWING TITLE:											
Building 2 Level 1 Floor Plan											
SCALE: @ B1	DRAW	N:	CHECKED:	DATE	:						
1:200	Е	EJ MFJ		16.12.201							
PROJECT No:		DWG	ISSUE:								
17-0049		D	1								






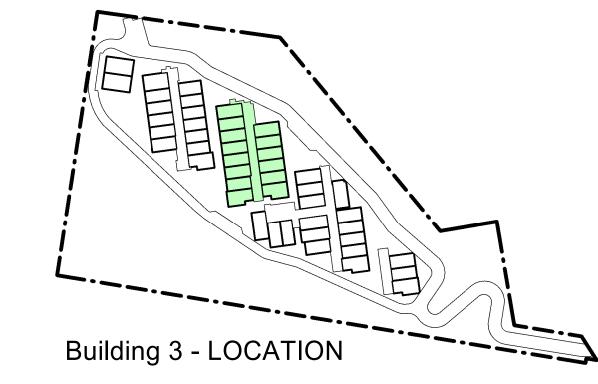

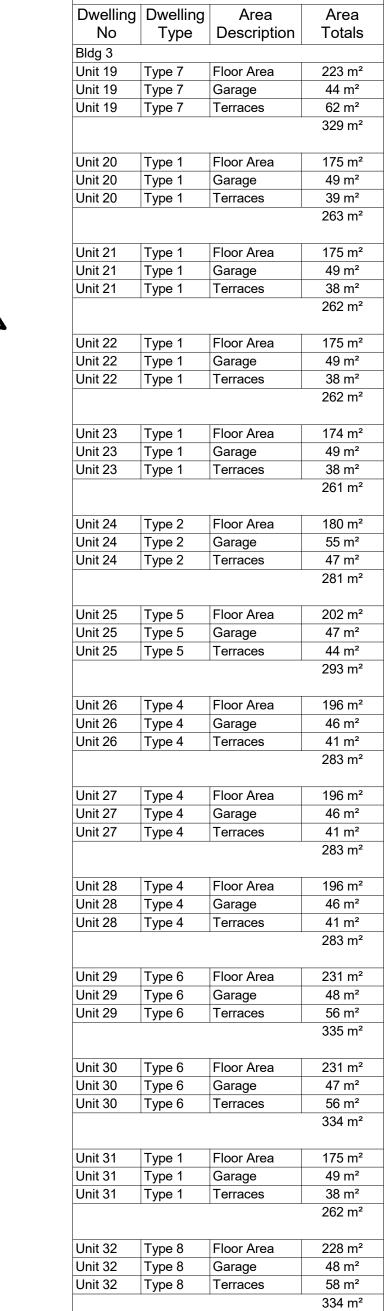

DWELLING AREA SCHEDULE - Building 3

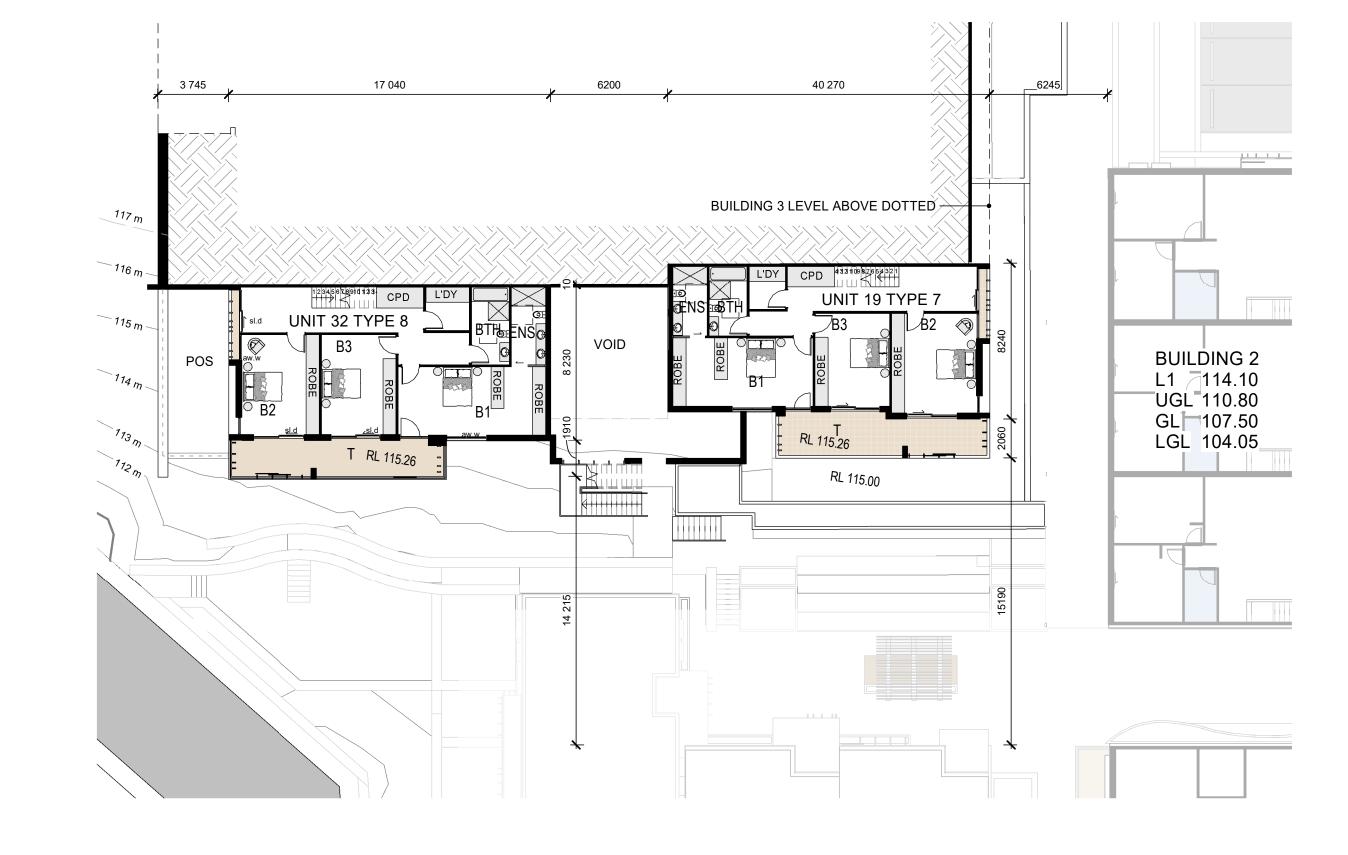

Building 3 - Lower Ground Level

LEGEND - ROOMS


В	BEDROOM
BTH	BATH
D	DINING
ENS	ENSUITE
ENT	ENTRY
G	GARAGE
K	KITCHEN
L	LIVING
אחו	LAHNDDV

- LAUNDRY TERRACE (POS) WALK IN ROBE PRIVATE OPEN SPACE YARD
- WIR POS REDUCE LEVEL (AHD)

THE BUILDING FLOOR PLANS ARE TO BE READ IN CONJUNCTION WITH THE FOLLOWING DOCUMENTS;


- REFER TO DRAWINGS DA/22 & DA/23 FOR THE 1:100 DWELLING TYPOLOGY PLANS (ROOM SIZES & FINISHES) REFER TO THE LANDSCAPE ARCHITECTS DOCUMENTATION
- FOR THE PROPOSED EXTERNAL SOFT AND HARD LANDSCAPE WORKS (FINISHES AND LEVELS)

REFER TO THE CIVIL ENGINEERS DOCUMENTATION FOR

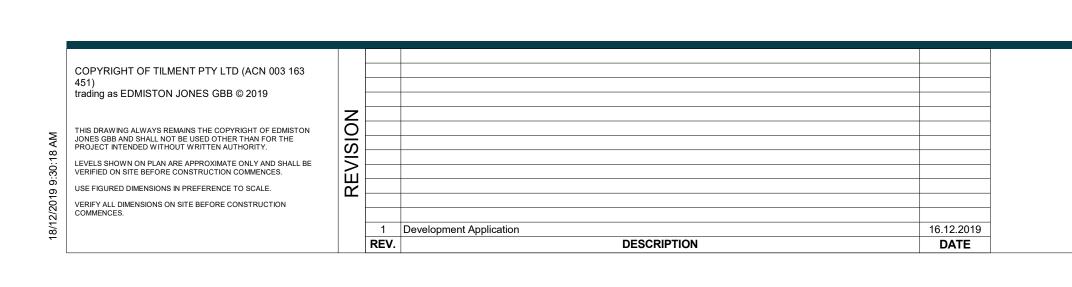

Building 3 - Ground Level



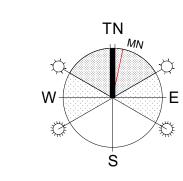

 PROJECT: Proposed Residential Development THE COSGROVE
At Lot 90 in D.P. 1086429, 14 Cosar


At Lot 90 in D.P. 1086429, 14 Cosgrove A Keiraville, NSW, 2500 T 02 4226 3600 T 02 4421 6822 T 02 4472 738

W www.aej.com.au E aej@aej.com.au


Avenue,	SCALE: @ B1	D
wondo,	1:200	
BAY 388	PROJECT No:	
500	17-0049	

DRAWING TITLE: Building 3 Lower Ground and Ground Level Floor Plans CHECKED: DATE: MFJ 16.12.2019



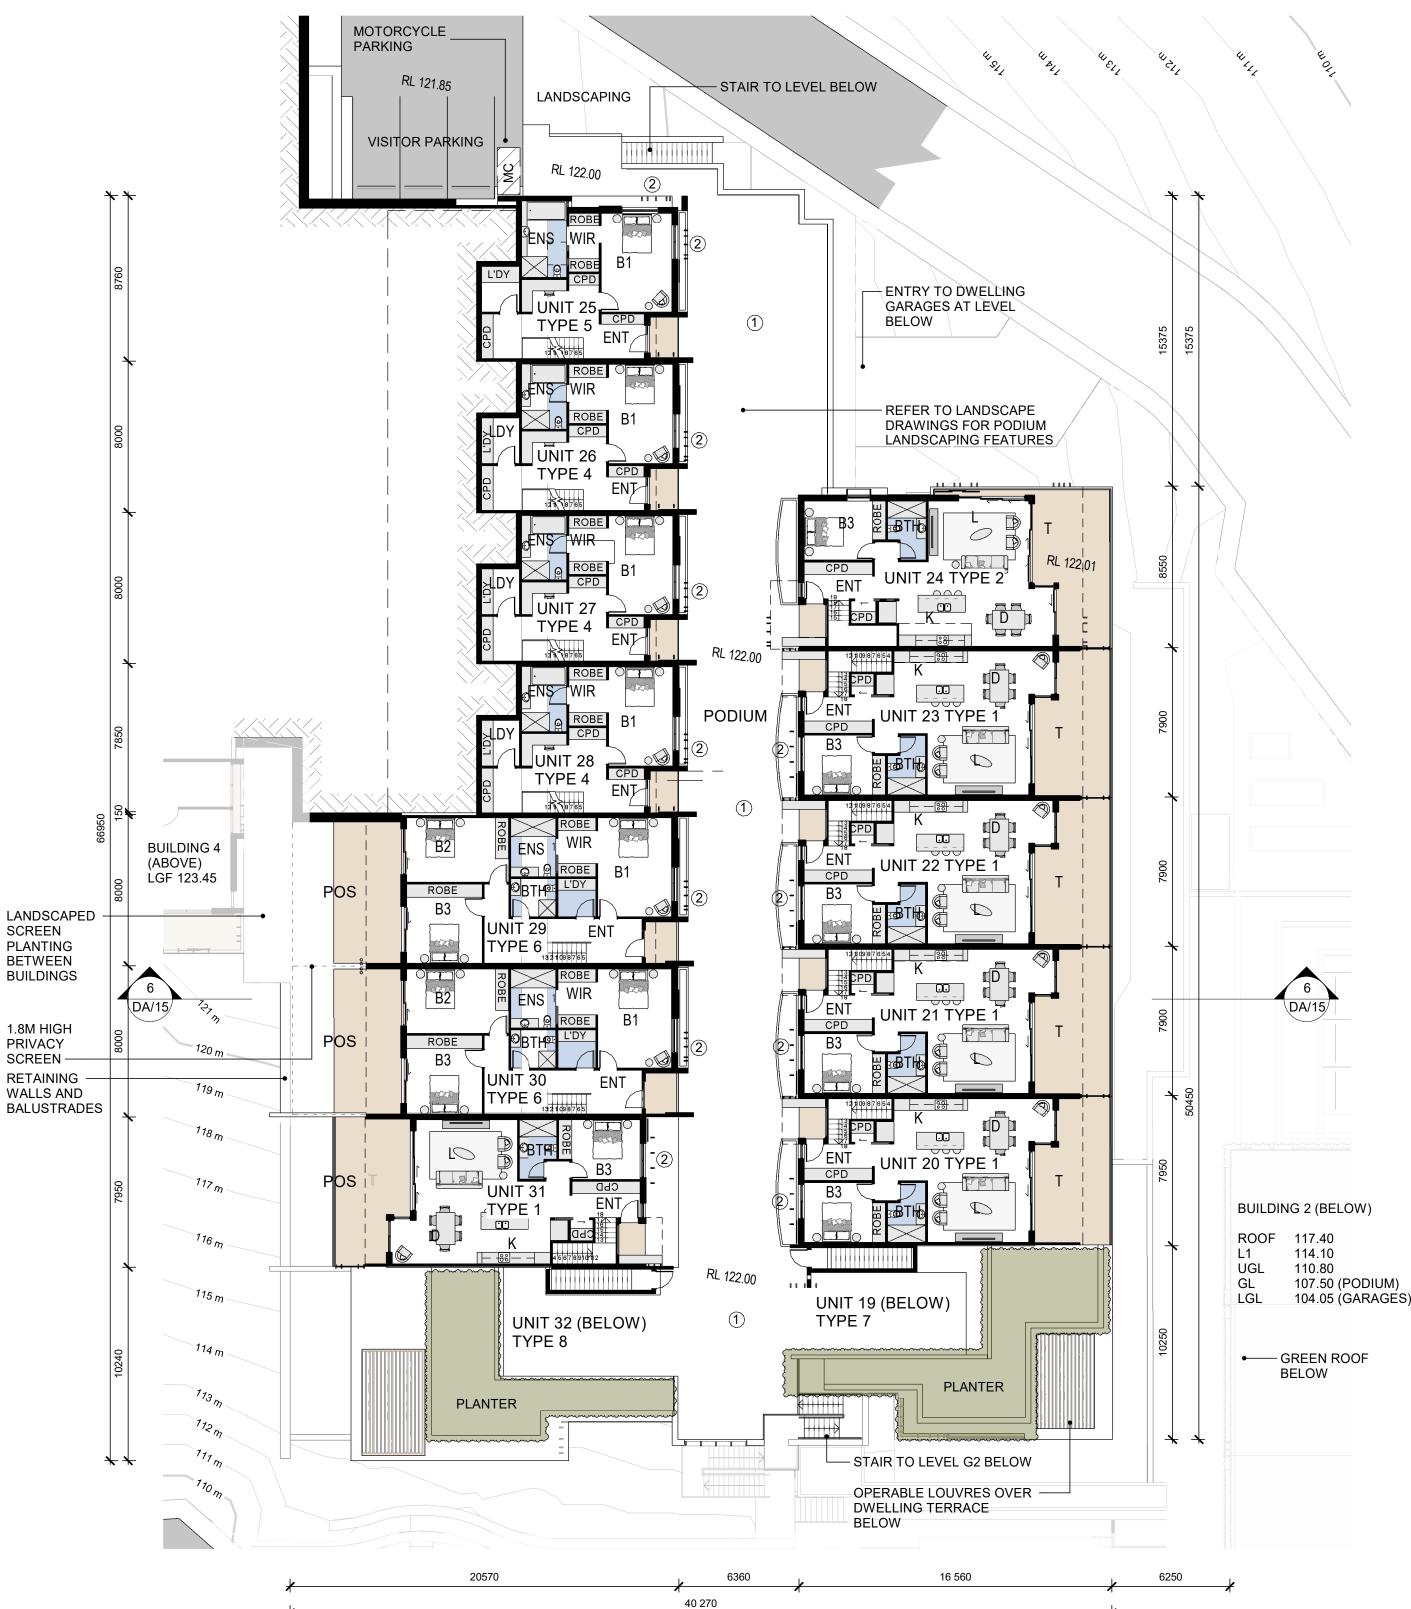

Building 3 - Level One Building 3 - Upper Ground Level

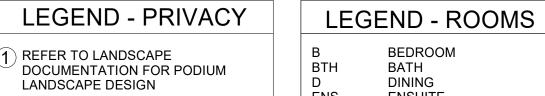

BTH BATH ENS ENT ENSUITE ENTRY GARAGE 2 DWELLING PRIVACY CONTROL TO BEDROOMS WINDOWS ADJACENT TO KITCHEN LIVING LAUNDRY TERRACE (POS)

RAISED PLANTER BEDS IN FRONT OF BEDROOM WINDOWS WIR POS VERTICAL FIXED BATTENS WITH PRIVATE OPEN SPACE YARD CLIMBING PLANTS REDUCE LEVEL (AHD) SLIDING EXTERNAL SCREENS TO BEDROOM WINDOWS

WALK IN ROBE

NOTES

Building 3 - LOCATION

THE BUILDING FLOOR PLANS ARE TO BE READ IN CONJUNCTION WITH THE FOLLOWING DOCUMENTS; REFER TO DRAWINGS DA/22 & DA/23 FOR THE 1:100 DWELLING TYPOLOGY PLANS (ROOM SIZES & FINISHES) REFER TO THE LANDSCAPE ARCHITECTS DOCUMENTATION

DWELLING AREA SCHEDULE - Building 3.

Type Description Totals

Terraces

44 m²

329 m²

175 m²

49 m² 39 m² 263 m²

175 m²

38 m²

262 m²

175 m²

49 m²

38 m² 262 m²

174 m² 49 m² 38 m²

180 m²

281 m²

47 m²

293 m²

196 m²

46 m²

41 m²

196 m²

46 m²

283 m²

196 m²

46 m²

283 m²

56 m²

47 m² 56 m²

334 m²

175 m²

49 m²

38 m²

228 m²

48 m² 58 m²

334 m²

Dwelling Dwelling Area

Unit 20 Type 1 Floor Area Unit 20 Type 1 Garage
Unit 20 Type 1 Terraces

Unit 21 Type 1 Terraces

Unit 22 Type 1 Terraces

Unit 23 Type 1 Floor Area
Unit 23 Type 1 Garage
Unit 23 Type 1 Terraces

Unit 24 Type 2 Floor Area
Unit 24 Type 2 Garage
Unit 24 Type 2 Terraces

Unit 25 Type 5 Floor Area
Unit 25 Type 5 Garage

Unit 25 Type 5 Terraces

Unit 26 Type 4 Floor Area

Unit 26 Type 4 Garage

Unit 26 Type 4 Terraces

Unit 27 Type 4 Floor Area

Unit 27 Type 4 Garage

Unit 27 Type 4 Terraces

Unit 28 Type 4 Floor Area

Unit 28 Type 4 Garage

Unit 29 Type 6 Garage

Unit 29 Type 6 Terraces

Unit 30 Type 6 Floor Area
Unit 30 Type 6 Garage
Unit 30 Type 6 Terraces

Unit 31 Type 1 Terraces

Unit 32 Type 8 Floor Area
Unit 32 Type 8 Garage
Unit 32 Type 8 Terraces

Unit 31

Unit 28 Type 4 Terraces

Type 6 Floor Area

Type 1 Floor Area
Type 1 Garage

Type 1 Floor Area
Type 1 Garage

Type 1 Floor Area
Type 1 Garage

Bldg 3 Unit 19 Unit 19


Unit 22

Unit 19 Type 7
Unit 19 Type 7

FOR THE PROPOSED EXTERNAL SOFT AND HARD LANDSCAPE WORKS (FINISHES AND LEVELS) REFER TO THE CIVIL ENGINEERS DOCUMENTATION FOR CIVIL WORKS

DA/14

COPYRIGHT OF TILMENT PTY LTD (ACN 003 163 trading as EDMISTON JONES GBB © 2019 THIS DRAWING ALWAYS REMAINS THE COPYRIGHT OF EDMISTON JONES GBB AND SHALL NOT BE USED OTHER THAN FOR THE PROJECT INTENDED WITHOUT WRITTEN AUTHORITY. LEVELS SHOWN ON PLAN ARE APPROXIMATE ONLY AND SHALL BE VERIFIED ON SITE BEFORE CONSTRUCTION COMMENCES. USE FIGURED DIMENSIONS IN PREFERENCE TO SCALE. VERIFY ALL DIMENSIONS ON SITE BEFORE CONSTRUCTION COMMENCES. 16.12.2019 Development Application DESCRIPTION DATE

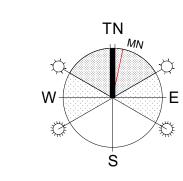

.	PROJECT: Proposed Residential Development THE COSGROVE


PEDESTRIAN AREAS:

At Lot 90 in D.P. 1086429, 14 Cosgrove Aven Keiraville, NSW, 2500


WOLLONGONG NOWRA **W** www.aej.com.au **E** aej@aej.com.au


0	1	2	3	4	5	6	7	8	9	10	11	12	13	14	15	16	17	18	
Bu	ild	in	g 3	3 U	pp	эе	r C	Gro	our	nd	Le	e∨€	el a	an	d L	_e	vel	1	
sc		Ŭ				DR				Cł			D:	-			.20	19)
	Bu Flo	DRAW Build Floor	DRAWING Building Floor P SCALE: @	DRAWING TIT	DRAWING TITLE: Building 3 U Floor Plans SCALE: @ B1	DRAWING TITLE: Building 3 Upp Floor Plans SCALE: @ B1	DRAWING TITLE: Building 3 Uppe Floor Plans SCALE: @ B1 DR	DRAWING TITLE: Building 3 Upper 0 Floor Plans SCALE: @ B1 DRAW	DRAWING TITLE: Building 3 Upper Gro Floor Plans SCALE: @ B1 DRAWN:	DRAWING TITLE: Building 3 Upper Groun Floor Plans SCALE: @ B1 DRAWN:	DRAWING TITLE: Building 3 Upper Ground Floor Plans SCALE: @ B1 DRAWN: CI	DRAWING TITLE: Building 3 Upper Ground Le Floor Plans SCALE: @ B1 DRAWN: CHEC	DRAWING TITLE: Building 3 Upper Ground Level Floor Plans SCALE: @ B1 DRAWN: CHECKER	DRAWING TITLE: Building 3 Upper Ground Level a Floor Plans SCALE: @ B1 DRAWN: CHECKED:	DRAWING TITLE: Building 3 Upper Ground Level and Floor Plans SCALE: @ B1 DRAWN: CHECKED: D	DRAWING TITLE: Building 3 Upper Ground Level and L Floor Plans SCALE: @ B1 DRAWN: CHECKED: DATE	DRAWING TITLE: Building 3 Upper Ground Level and Level Floor Plans SCALE: @ B1 DRAWN: CHECKED: DATE:	DRAWING TITLE: Building 3 Upper Ground Level and Level Floor Plans SCALE: @ B1 DRAWN: CHECKED: DATE:	DRAWING TITLE: Building 3 Upper Ground Level and Level 1 Floor Plans SCALE: @ B1 DRAWN: CHECKED: DATE:

T 02 4226 3600 T 02 4421 6822 T 02 4472 7388 17-0049 ominated Architect Steven Bayer Reg. No. 5880

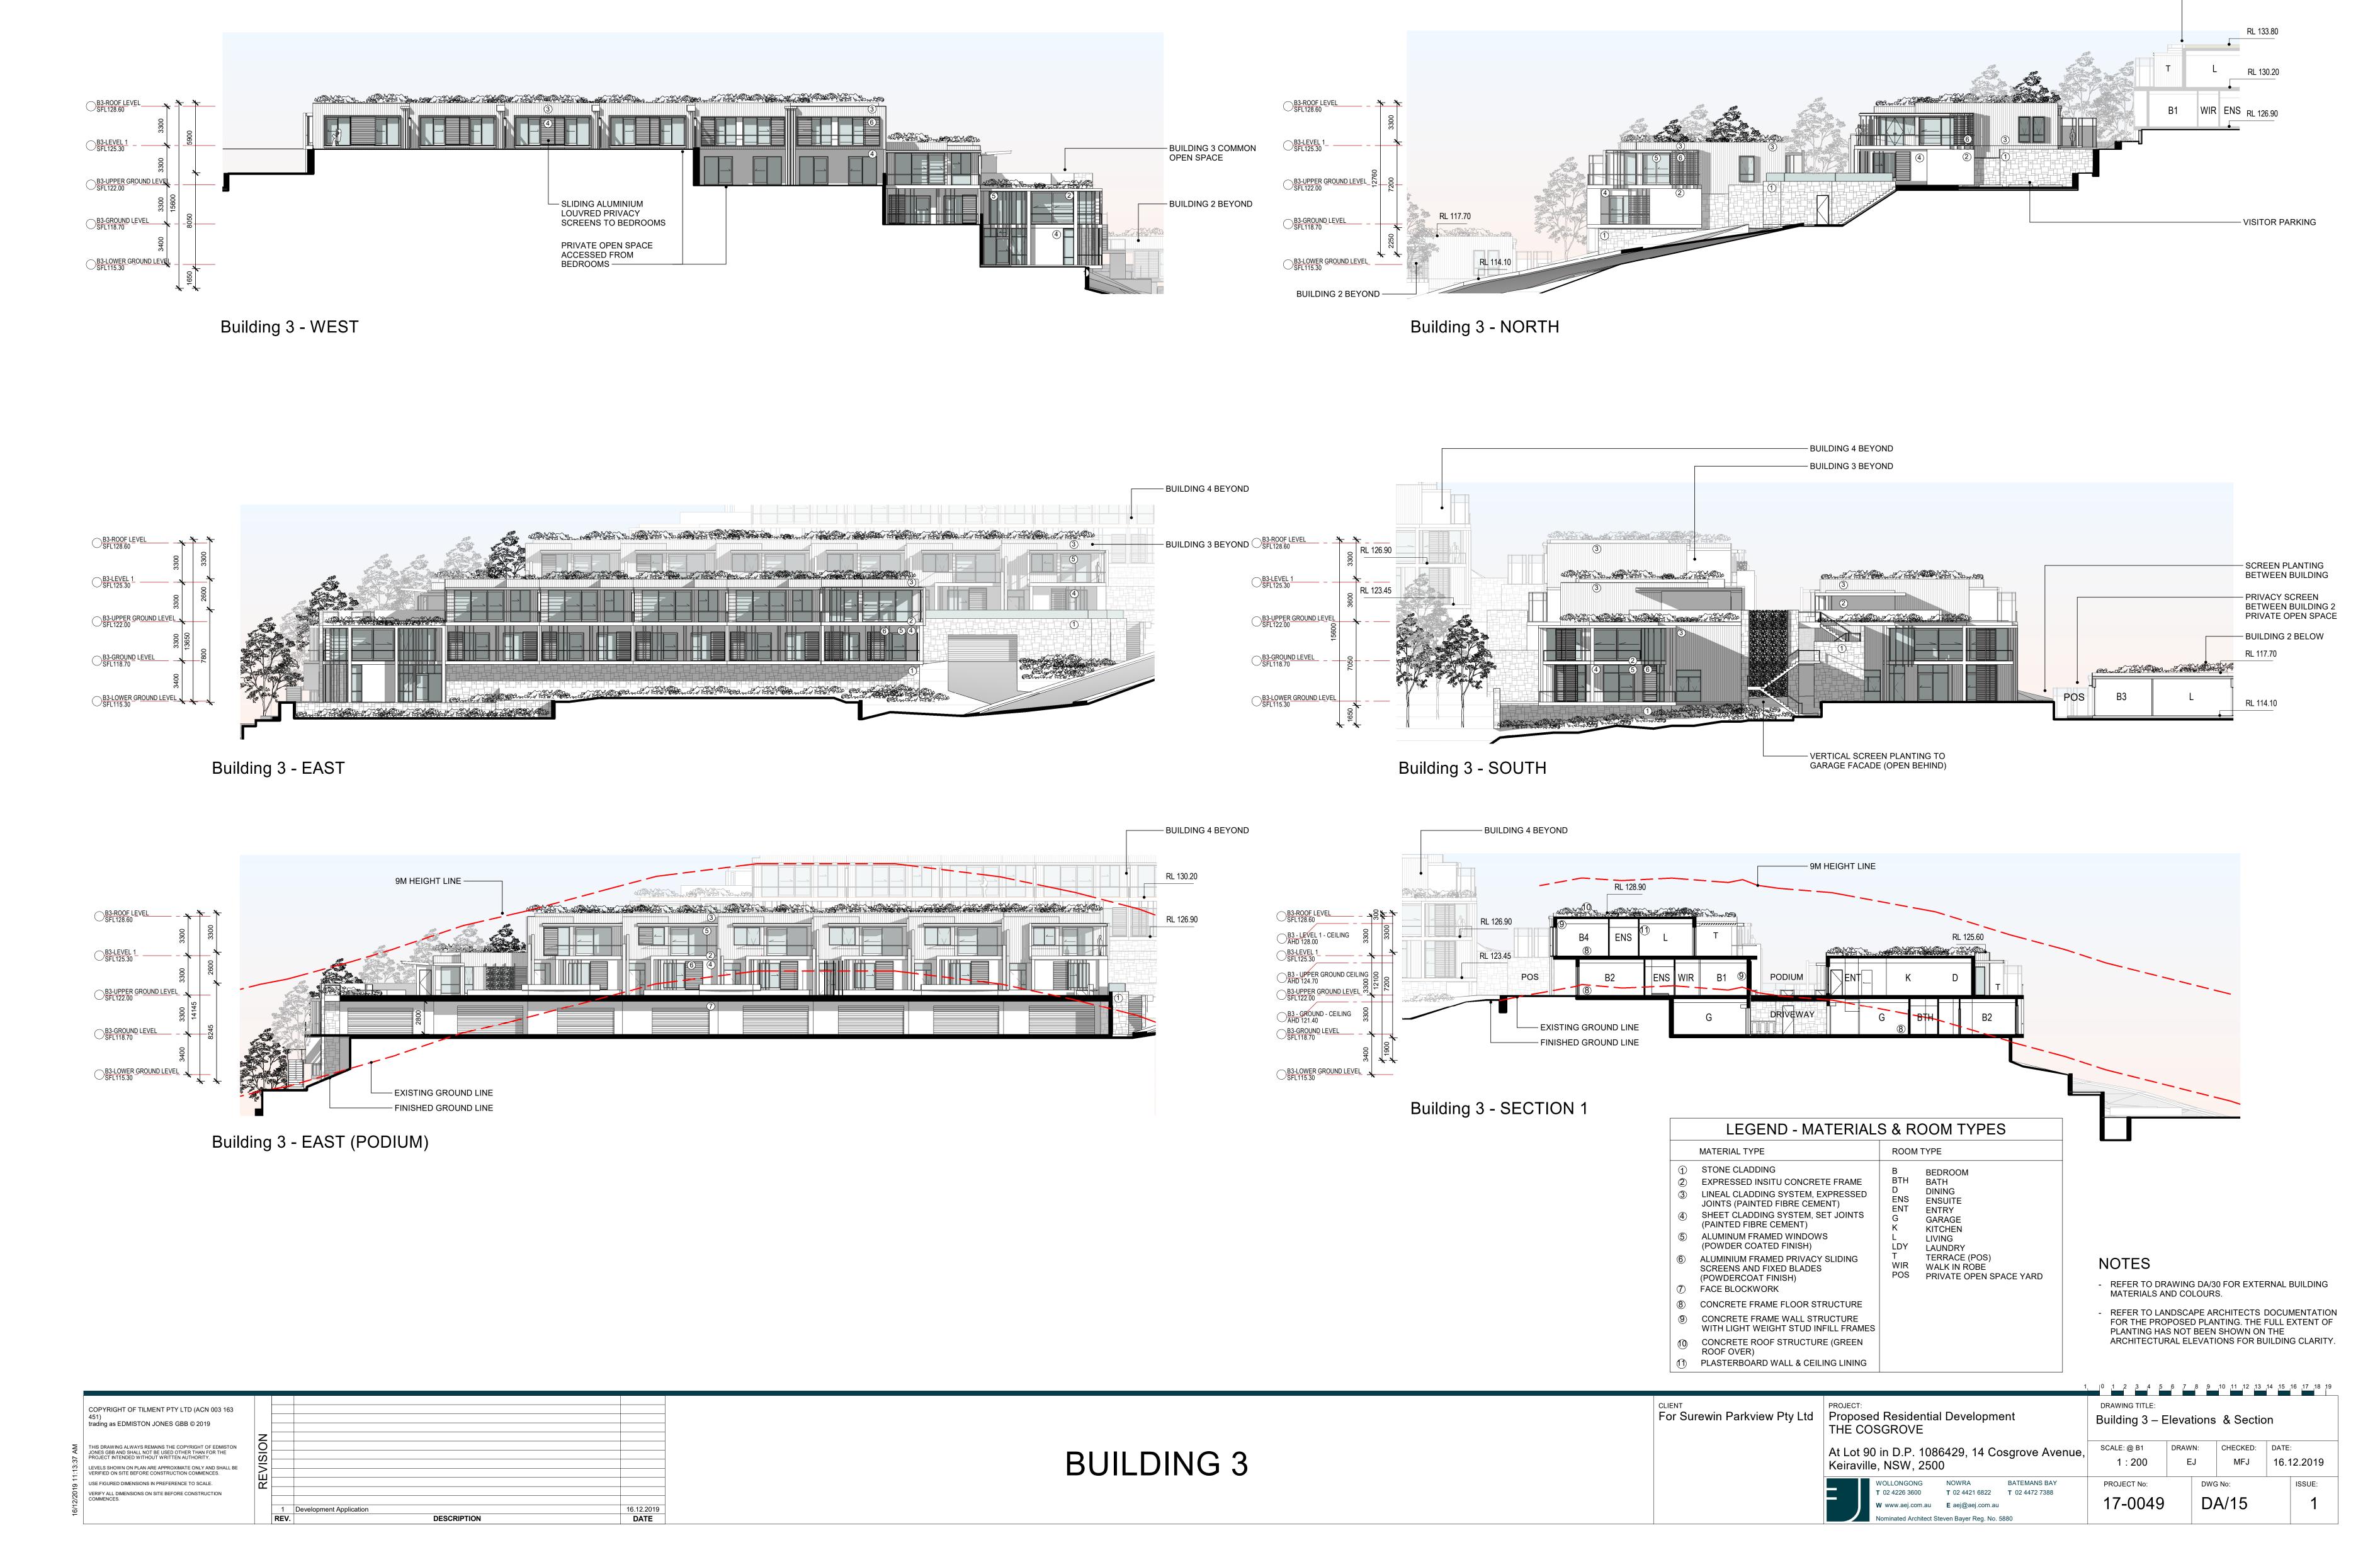



- BUILDING 4 ABOVE

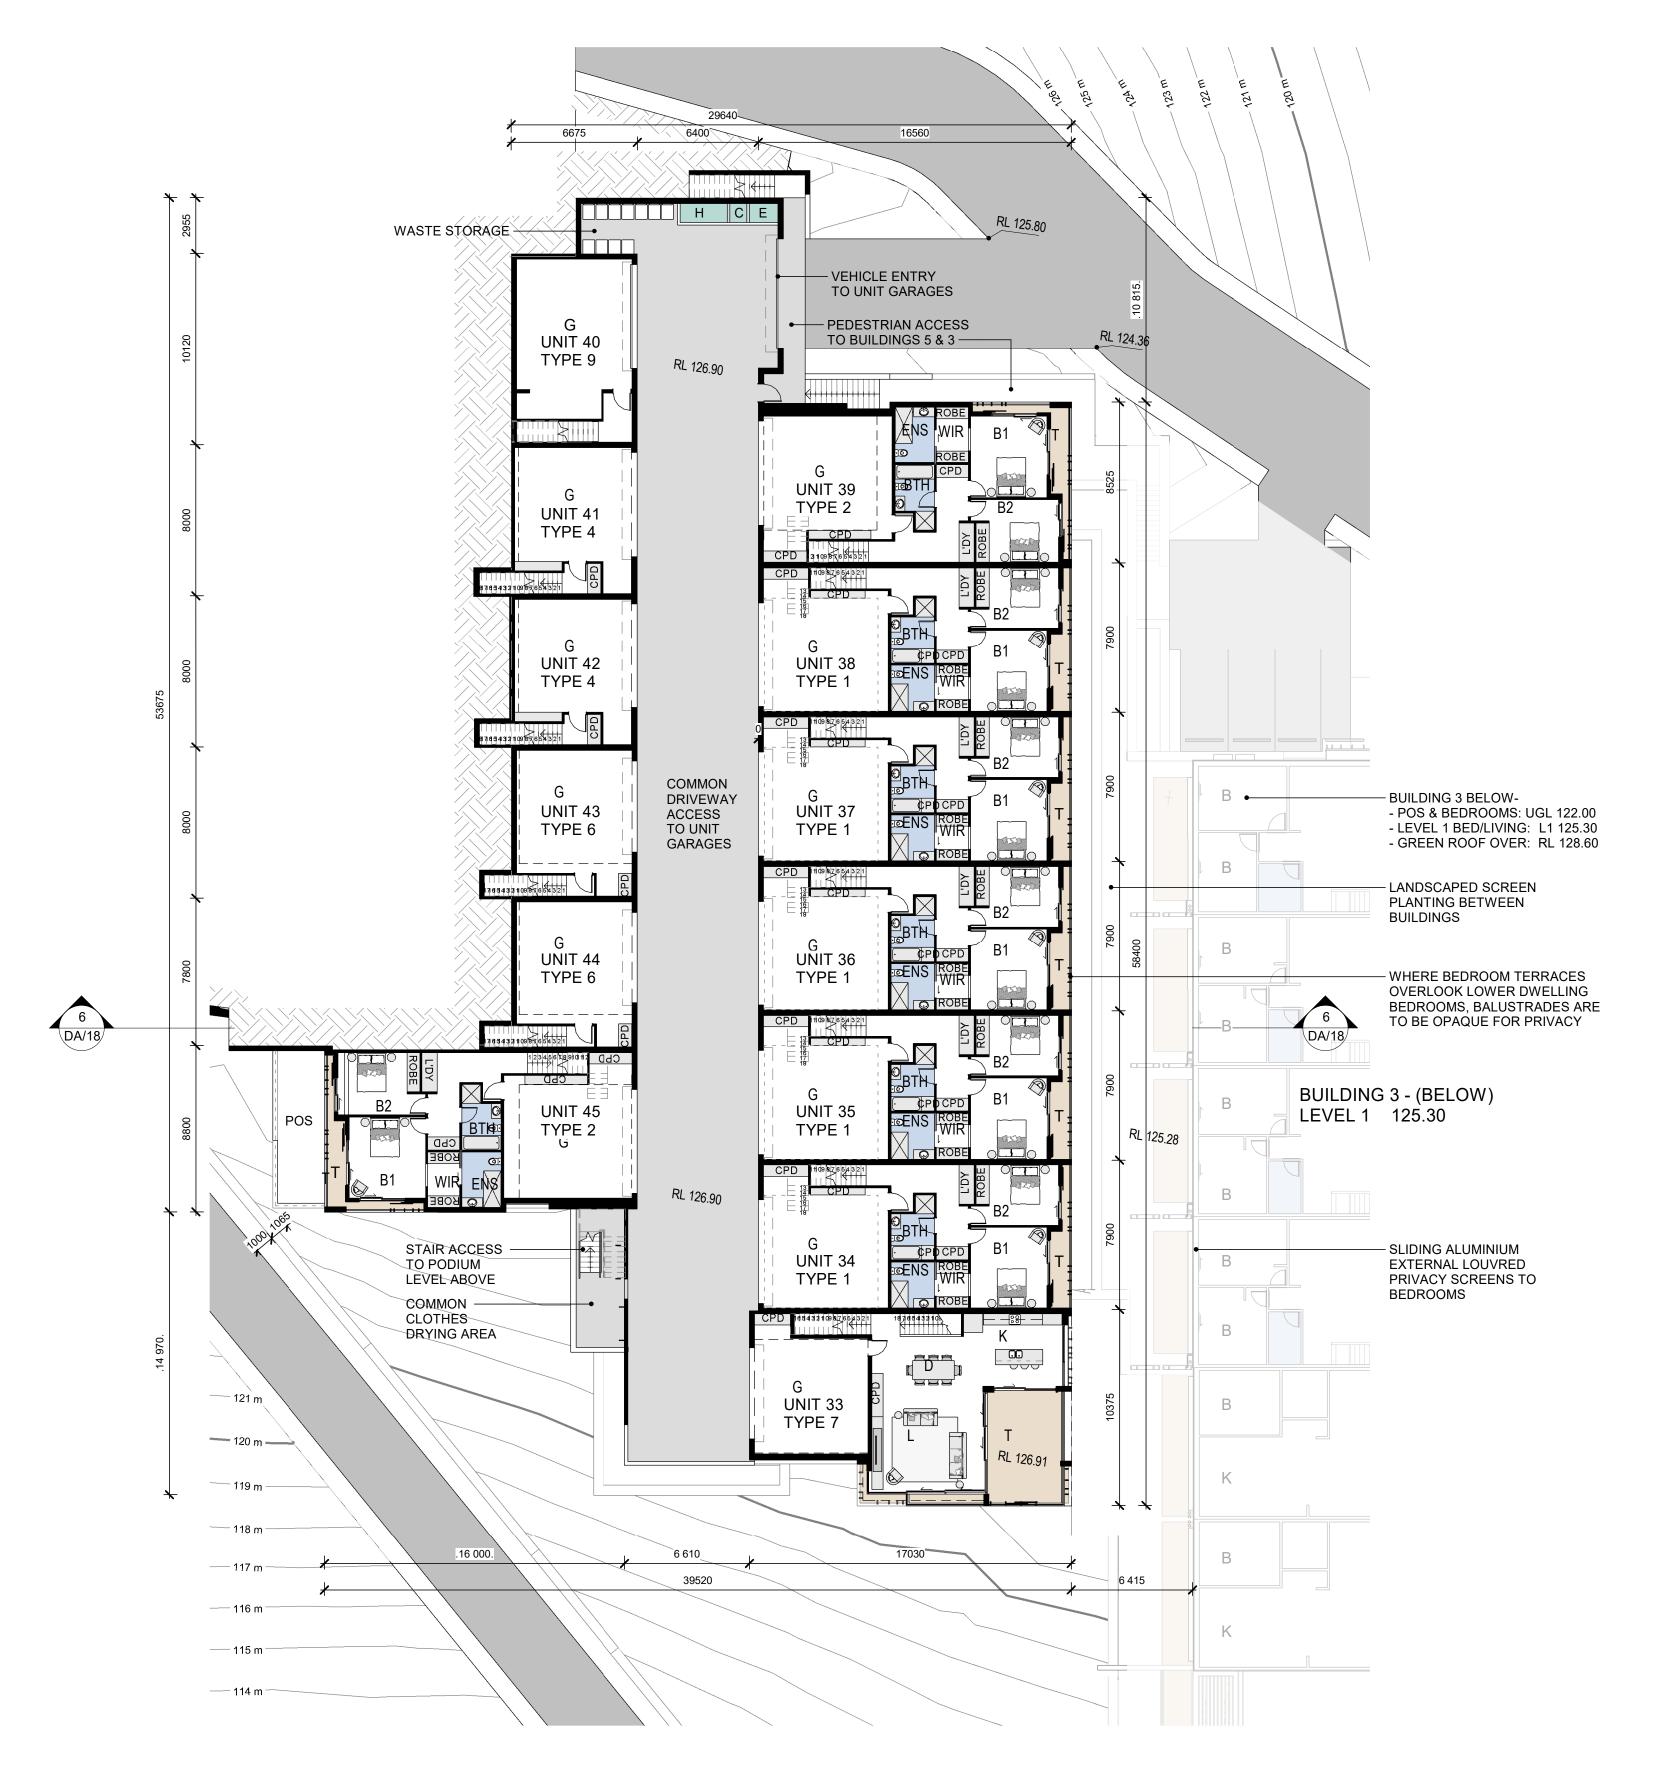

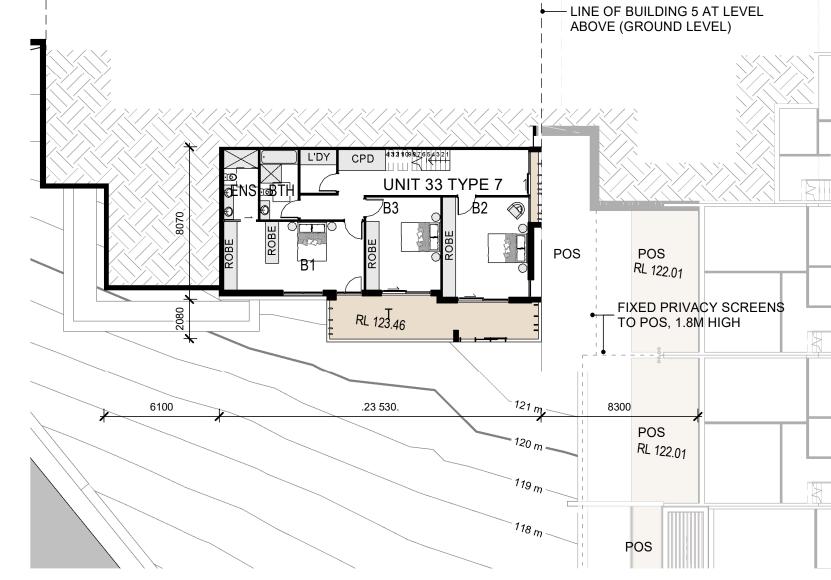

Building 4 - Lower Ground Level

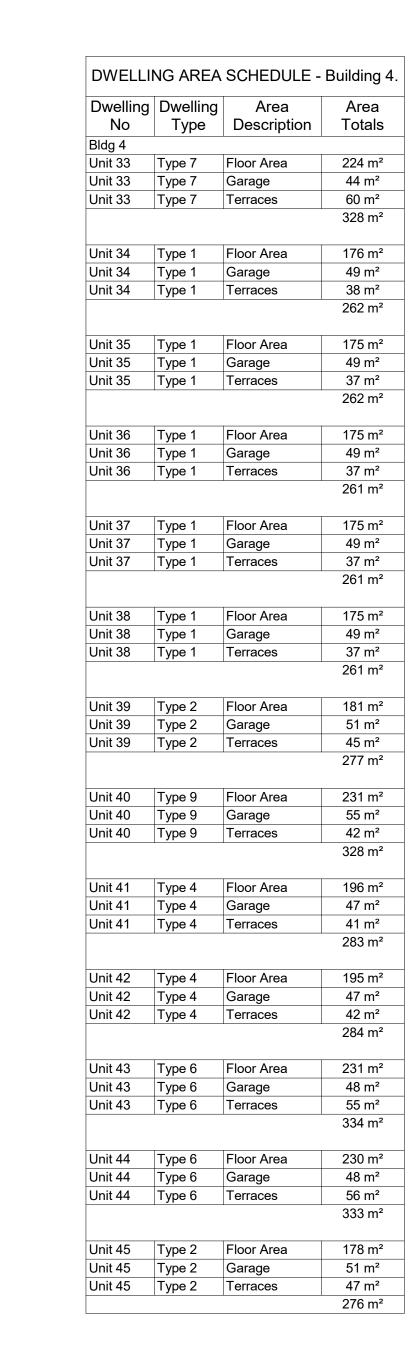

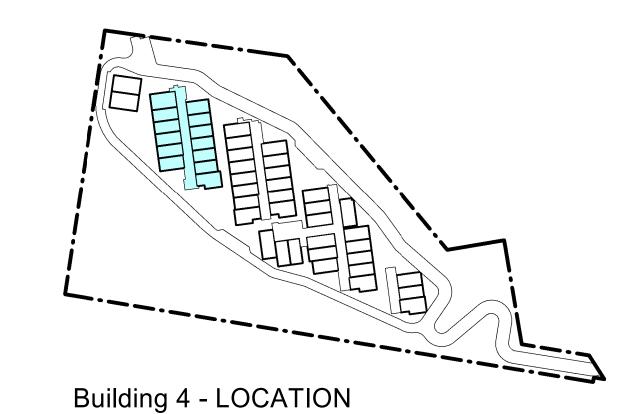


END.	ROOMS	

LEGEND - ROOMS						
B BTH D ENS ENT G K L LDY T WIR	BEDROOM BATH DINING ENSUITE ENTRY GARAGE KITCHEN LIVING LAUNDRY TERRACE (POS) WALK IN ROBE					
POS RL	PRIVATE OPEN SPACE YARD REDUCE LEVEL (AHD)					

NOTES


- THE BUILDING FLOOR PLANS ARE TO BE READ IN CONJUNCTION WITH THE FOLLOWING DOCUMENTS; REFER TO DRAWINGS DA/22 & DA/23 FOR THE 1:100 DWELLING TYPOLOGY PLANS (ROOM SIZES & FINISHES)
- REFER TO THE LANDSCAPE ARCHITECTS DOCUMENTATION FOR THE PROPOSED EXTERNAL SOFT AND HARD LANDSCAPE WORKS (FINISHES AND LEVELS)

REFER TO THE CIVIL ENGINEERS DOCUMENTATION FOR CIVIL WORKS

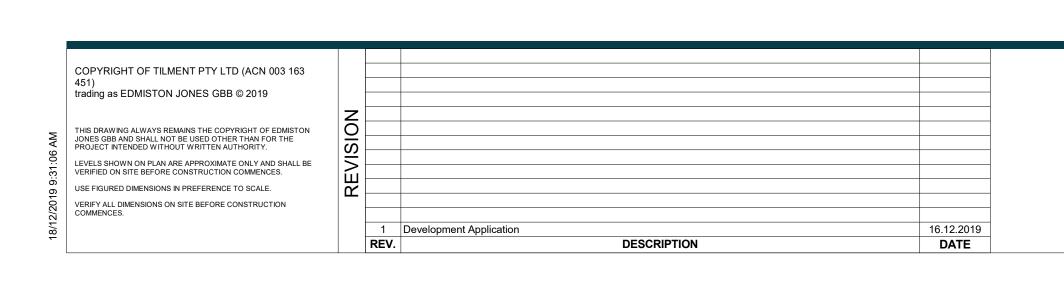

Building 4 - Ground Level



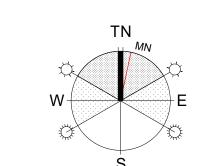

For Surewin Parkview Pty Ltd


PROJECT: Proposed Residential Development THE COSGROVE
At Lot 90 in D.P. 1086429, 14 Cosgrove Aver


SGROVE	-	
in D.P. 108 , NSW, 250		osgrove Avenue,
WOLLONGONG	NOWRA	BATEMANS BAY
T 02 4226 3600	T 02 4421 6822	T 02 4472 7388


	DRAWING TITLE:							
	Building 4 Lo Level Floor P		Grour	nd Le	evel	& C	Gro	und
ue,	SCALE: @ B1	DRAW	N:	CHEC	KED:	DA	ATE:	
ac,	1:200	E	J	М	FJ	1	6.1	2.201


ISSUE:



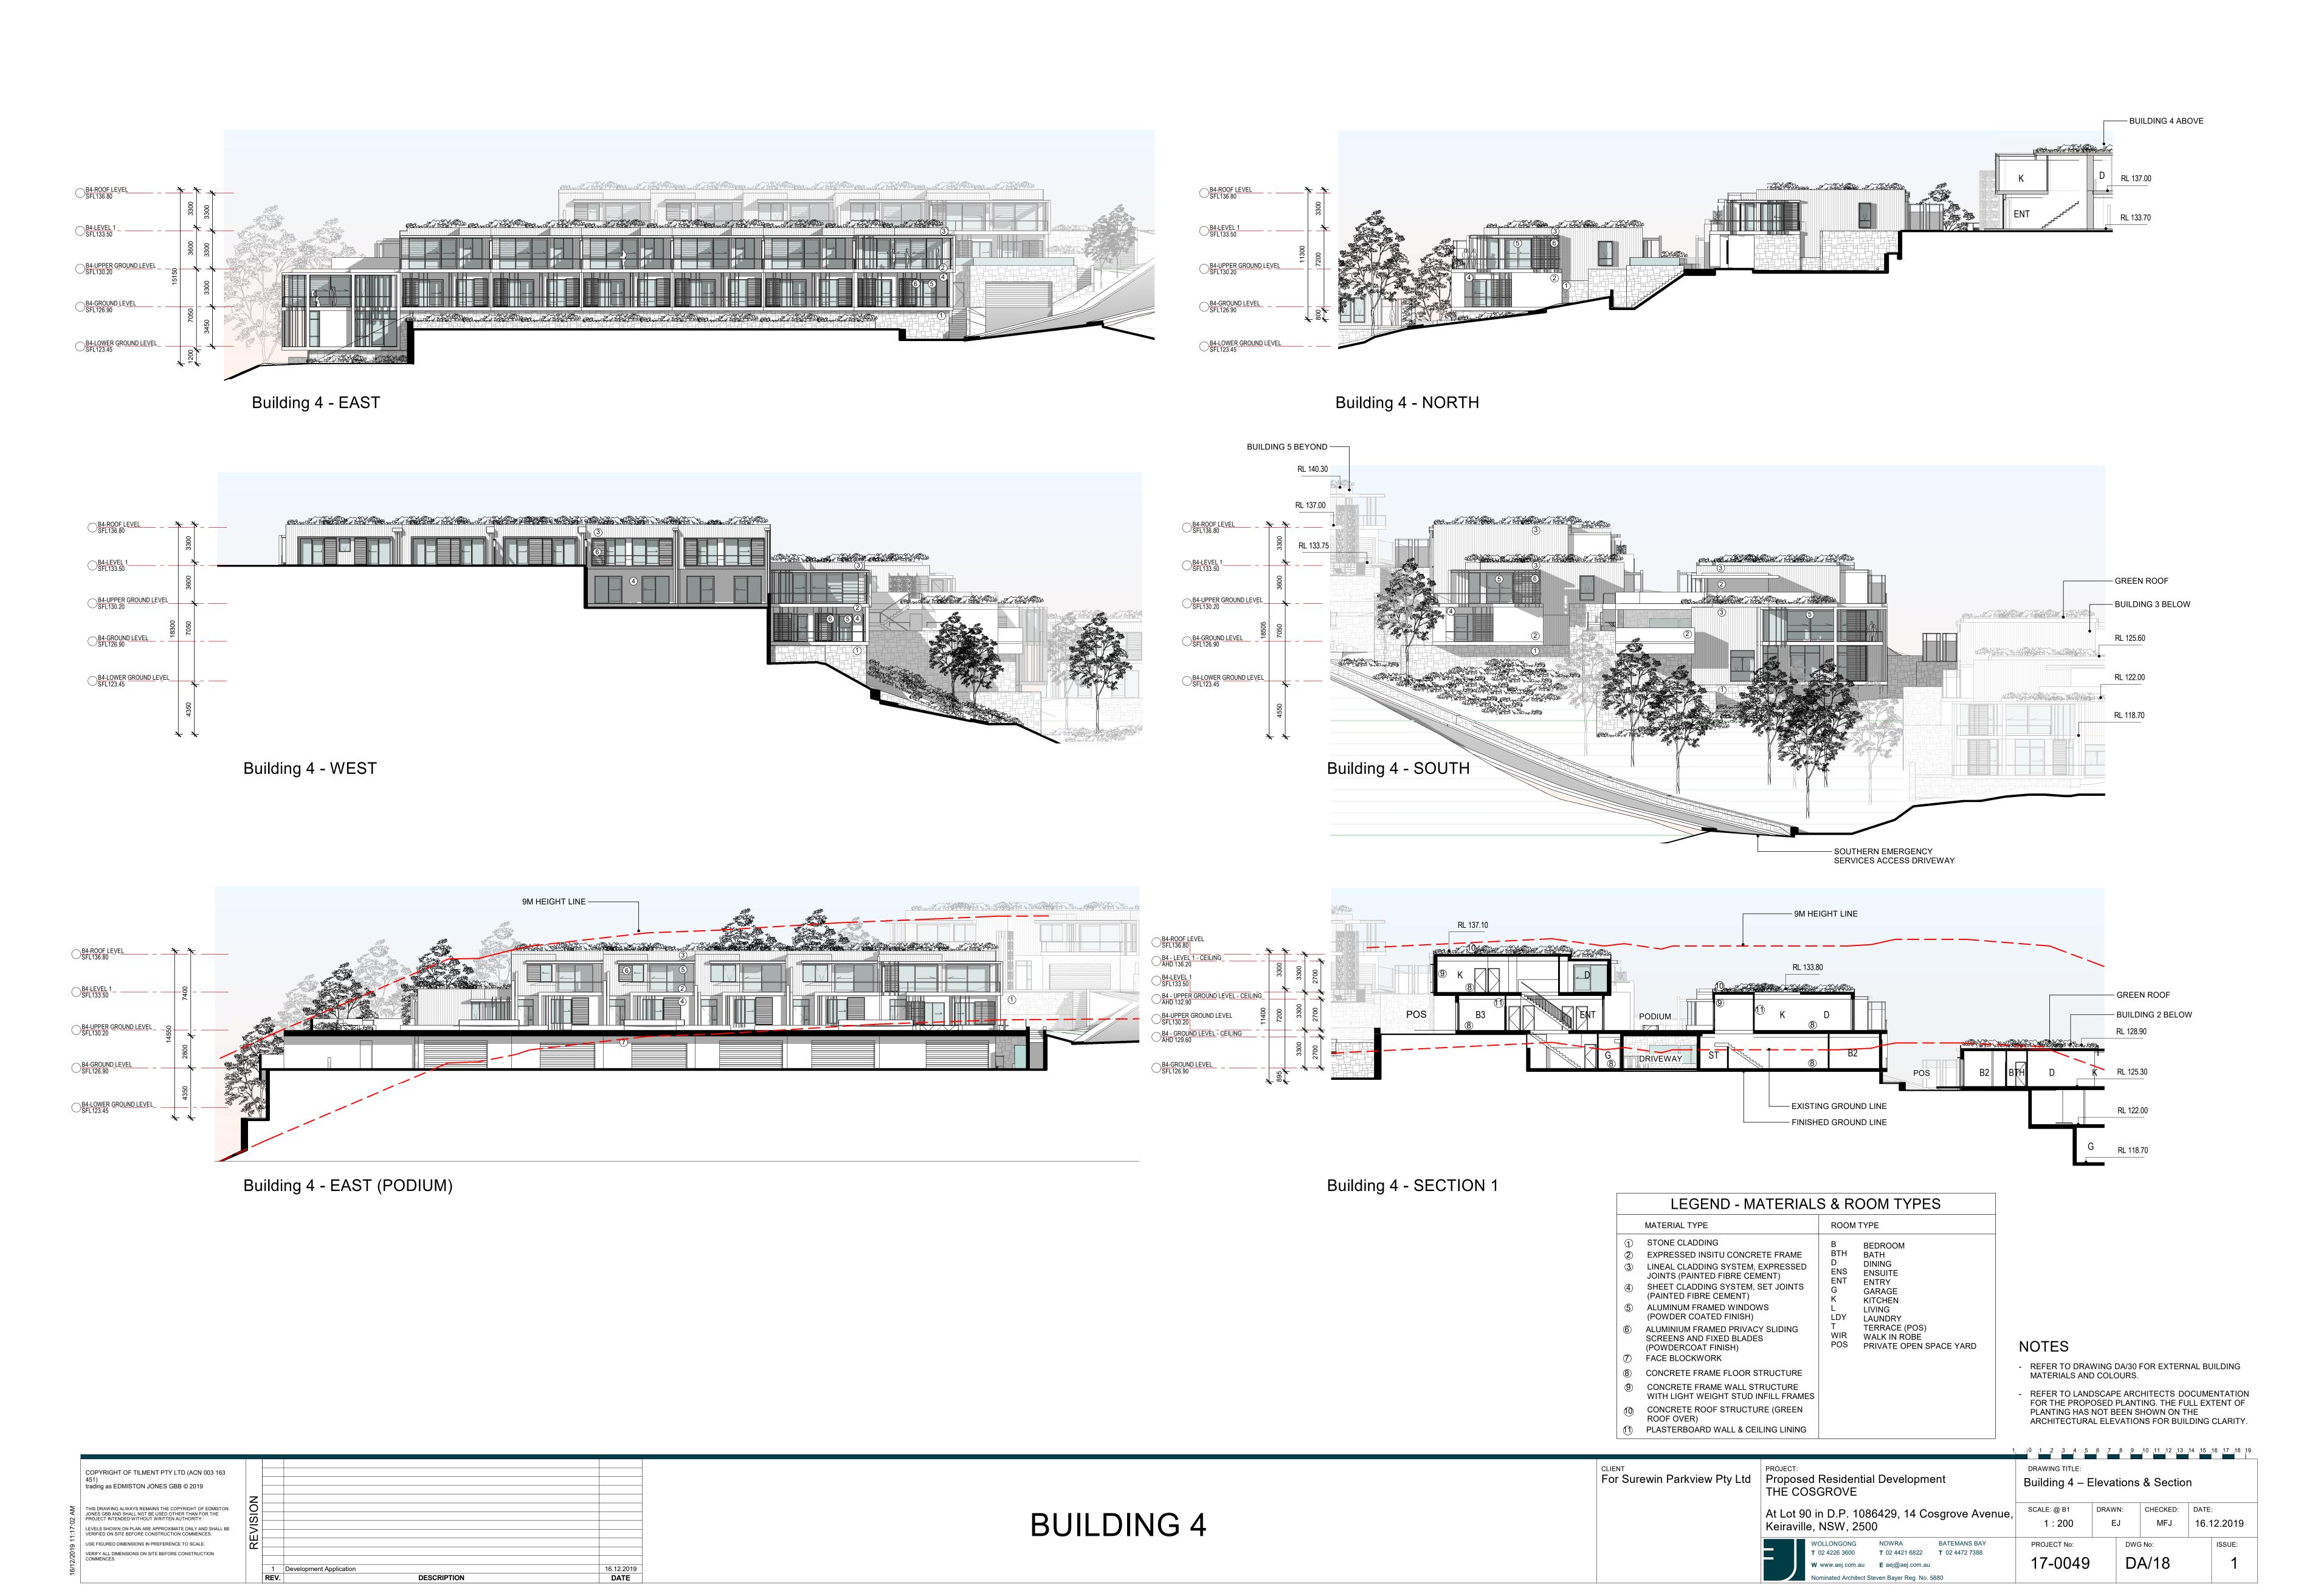


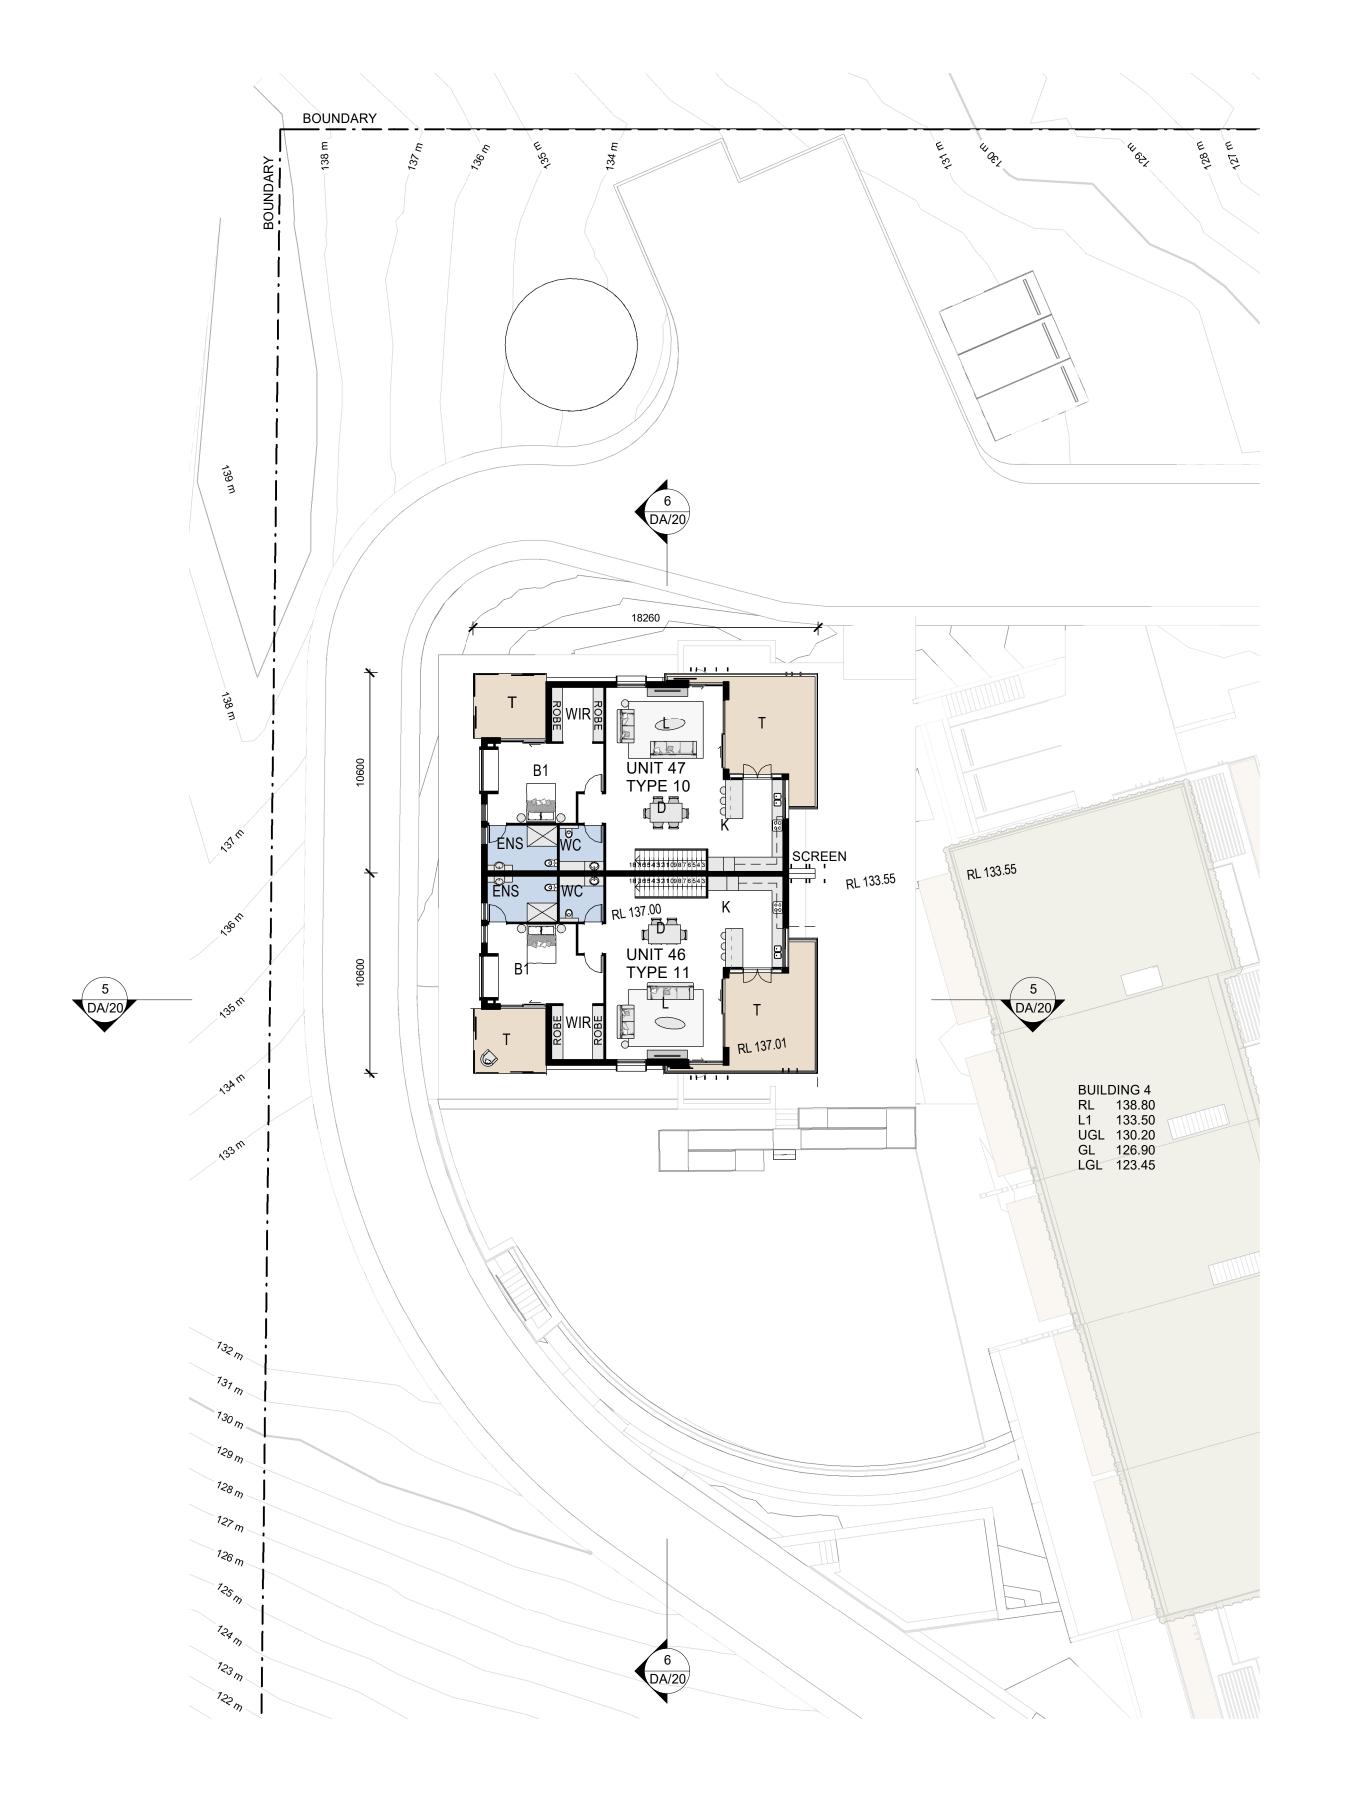

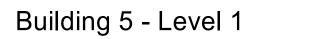

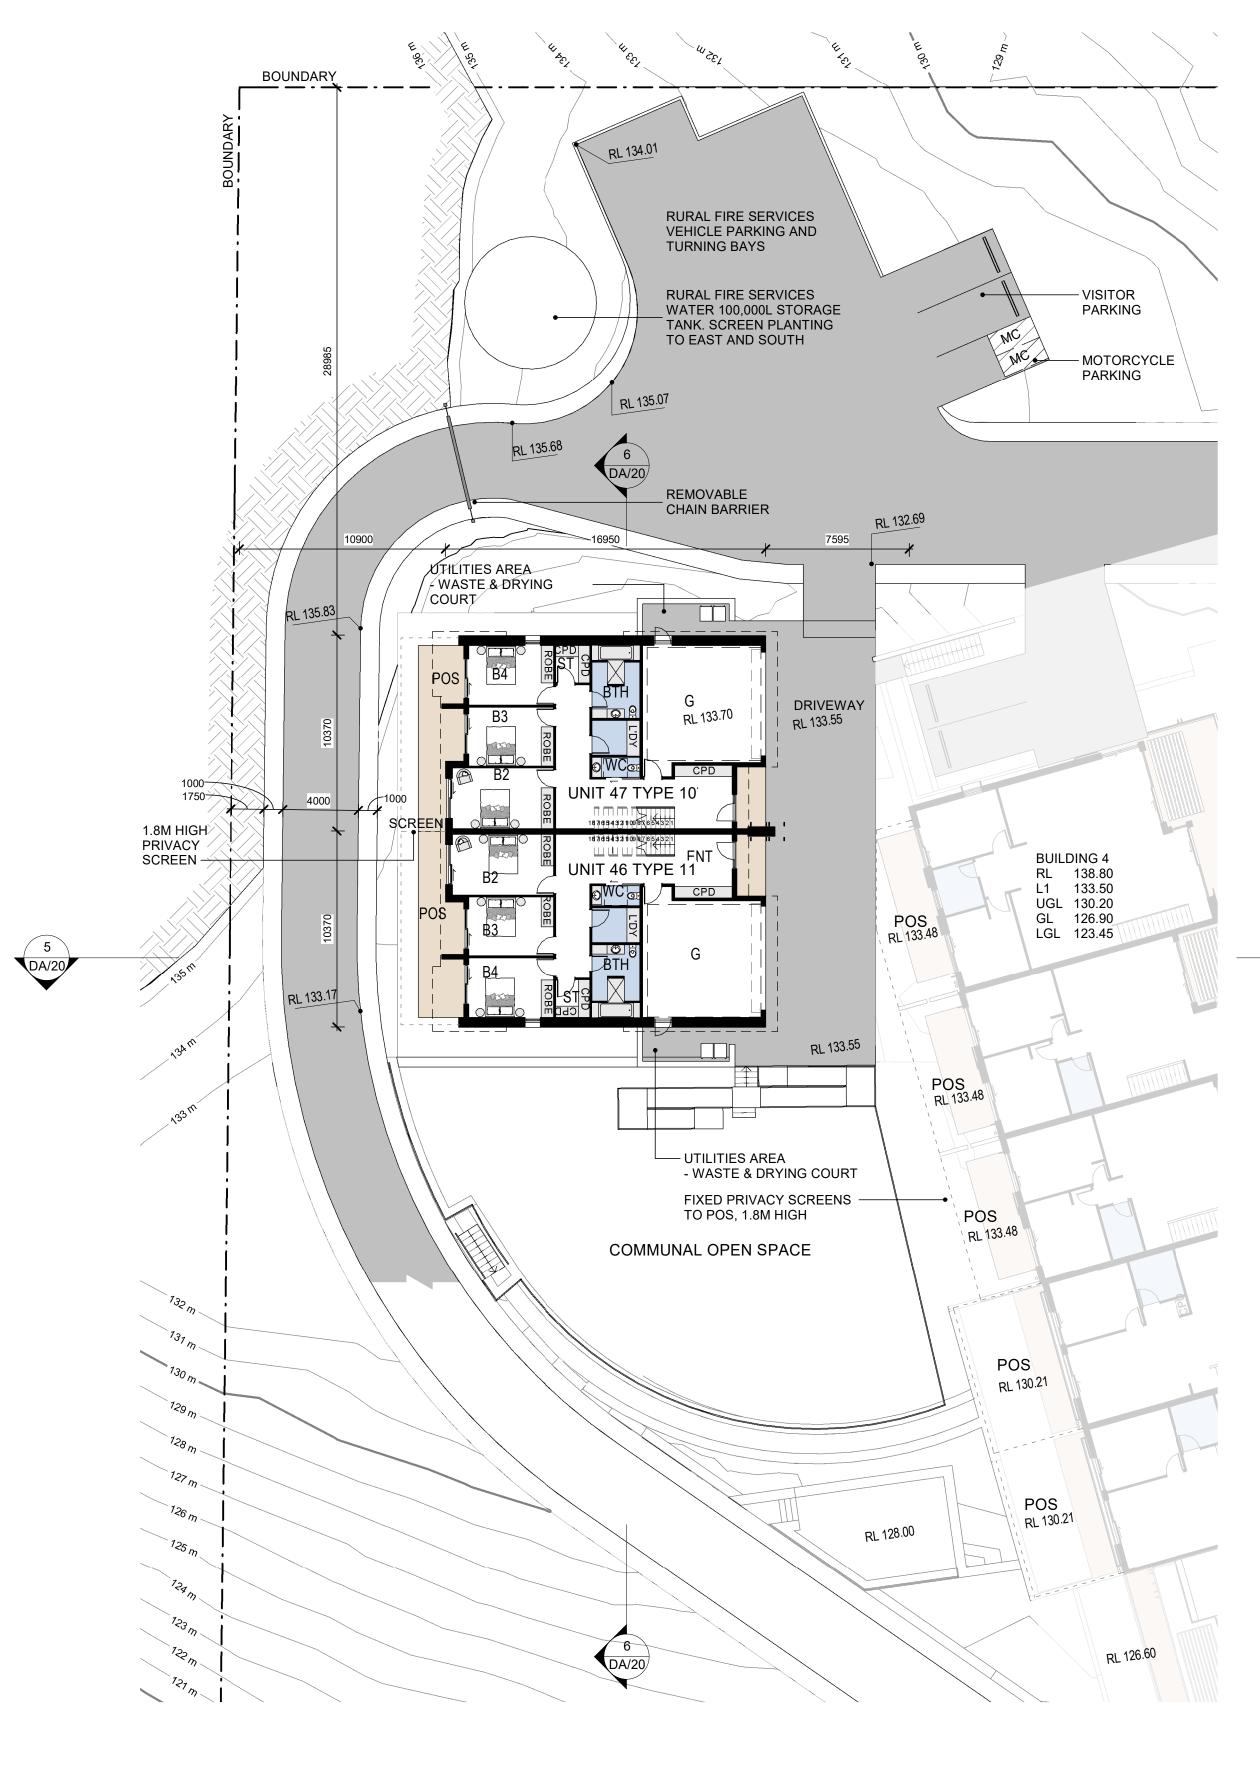

Building 5 - Ground Level

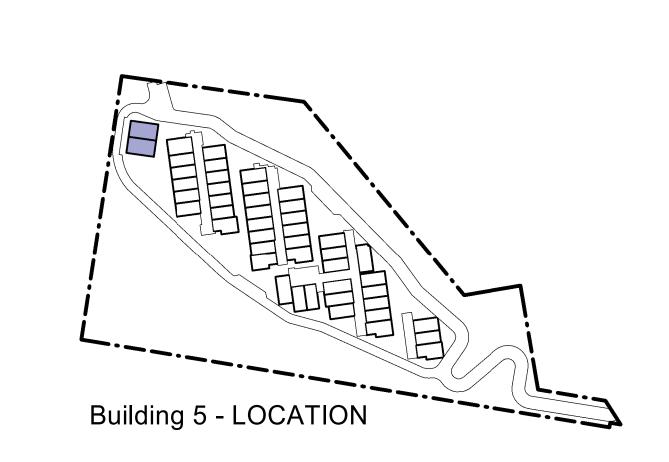

Dwelling No	Dwelling Type	Area Description	Area Total
Bldg 5			
Unit 46	Type 11	Floor Area	253 m²
Unit 46	Type 11	Garage	44 m²
Unit 46	Type 11	Terraces	56 m²
			353 m²
Unit 47	Type 10	Floor Area	252 m²
Unit 47	Type 10	Garage	43 m²
Unit 47	Type 10	Terraces	58 m²
			353 m²

LEGEND - ROOMS

5 DA/20

B BTH D ENS ENT G

- WIR POS RL
- BEDROOM
 BATH
 DINING
 ENSUITE
 ENTRY
 GARAGE
 KITCHEN
 LIVING
 LAUNDRY
 TERRACE (POS)
 WALK IN ROBE
 PRIVATE OPEN SPACE YARD
 REDUCE LEVEL (AHD)


NOTES

THE BUILDING FLOOR PLANS ARE TO BE READ IN CONJUNCTION WITH THE FOLLOWING DOCUMENTS;

- REFER TO DRAWINGS DA/22 & DA/23 FOR THE 1:100 DWELLING TYPOLOGY PLANS (ROOM SIZES & FINISHES)
- REFER TO THE LANDSCAPE ARCHITECTS DOCUMENTATION FOR THE PROPOSED EXTERNAL SOFT AND HARD LANDSCAPE WORKS (FINISHES AND LEVELS)
- REFER TO THE CIVIL ENGINEERS DOCUMENTATION FOR CIVIL WORKS

COPYRIGHT OF TILMENT PTY LTD (ACN 003 163 trading as EDMISTON JONES GBB © 2019 THIS DRAWING ALWAYS REMAINS THE COPYRIGHT OF EDMISTON JONES GBB AND SHALL NOT BE USED OTHER THAN FOR THE PROJECT INTENDED WITHOUT WRITTEN AUTHORITY. LEVELS SHOWN ON PLAN ARE APPROXIMATE ONLY AND SHALL BE VERIFIED ON SITE BEFORE CONSTRUCTION COMMENCES. USE FIGURED DIMENSIONS IN PREFERENCE TO SCALE. VERIFY ALL DIMENSIONS ON SITE BEFORE CONSTRUCTION COMMENCES. 16.12.2019 1 Development Application DESCRIPTION DATE

BUILDING 5

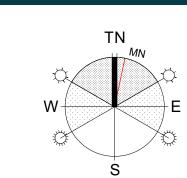

For Surewin Parkview Pty Ltd Proposed Residential Development THĖ COSGROVE At Lot 90 in D.P. 1086429, 14 Cosgrove Avenue,

W www.aej.com.au **E** aej@aej.com.au

Keiraville, NSW, 2500 WOLLONGONG

T 02 4226 3600 T 02 4421 6822 T 02 4472 7388


DRAWING TITLE: Building 5 Ground Level and Level 1 Floor Plans CHECKED: DATE: MFJ 16.12.2019 PROJECT No: ISSUE:

17-0049






Building 5 - WEST

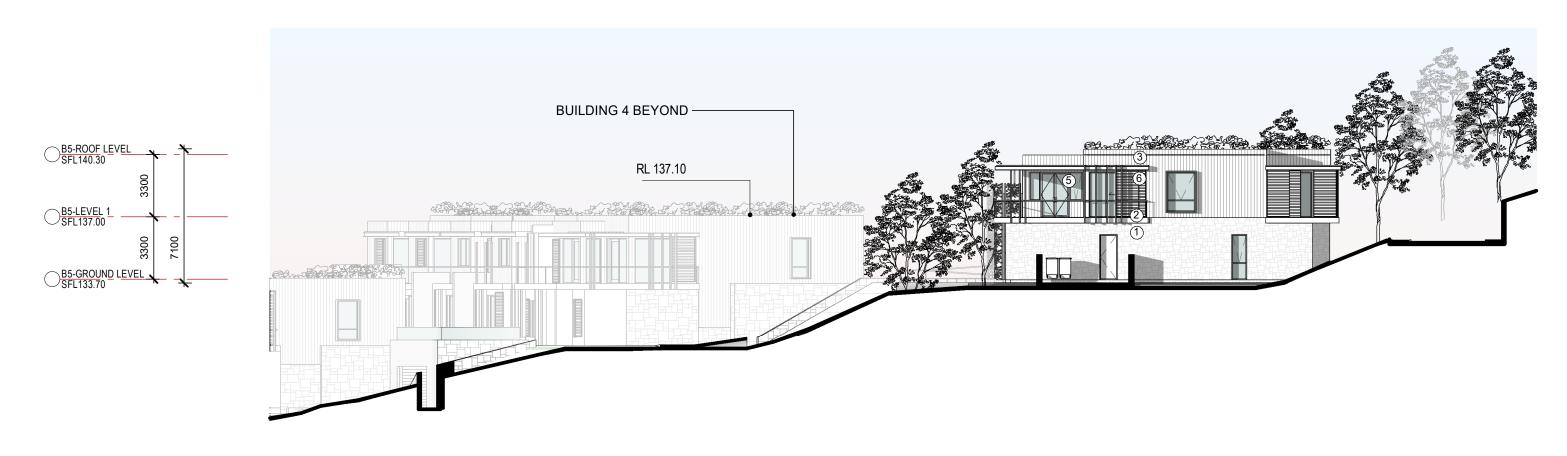




Building 5 - NORTH

Building 5 - EAST

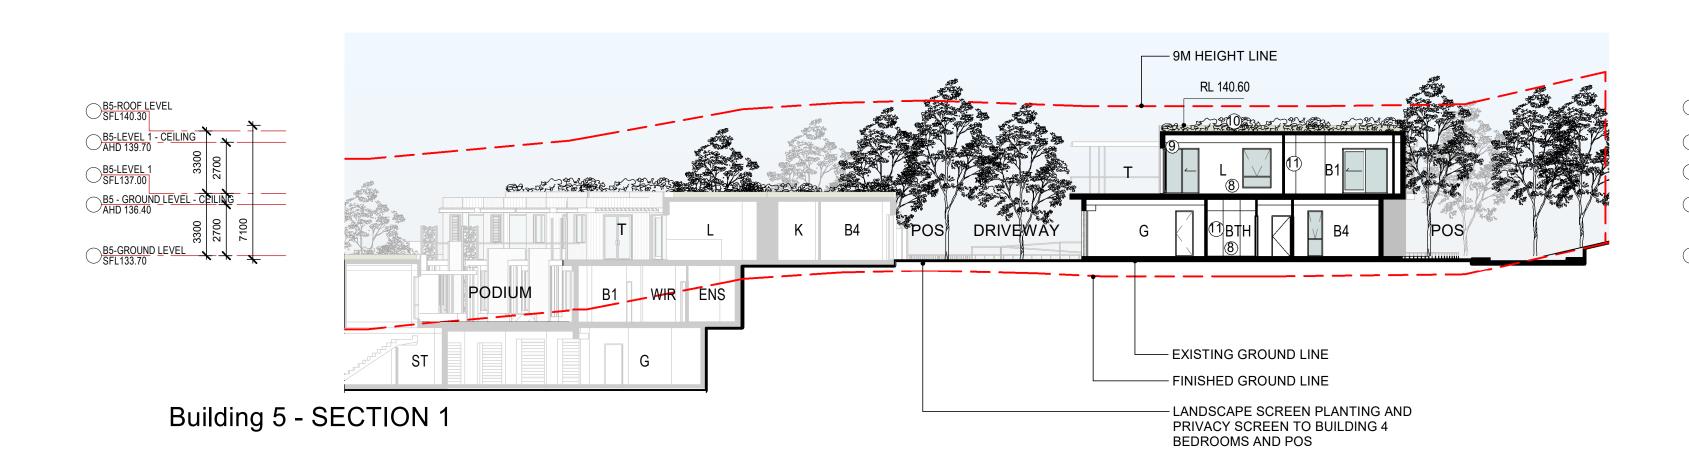

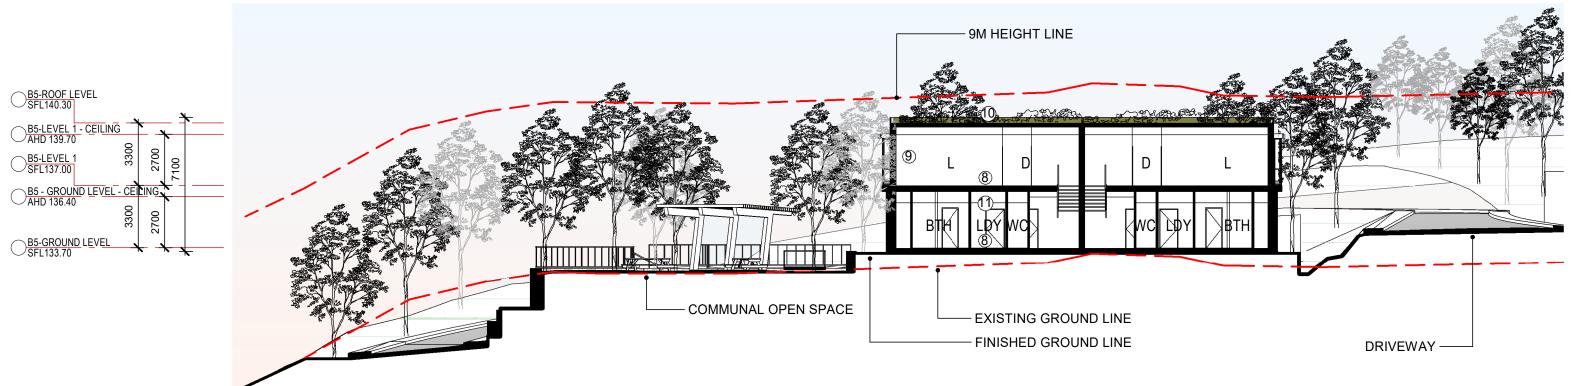

Building 5 - SECTION 2

		50014	T) (D.E.	
	MATERIAL TYPE	ROOM	TYPE	
)	STONE CLADDING	В	BEDROOM	
	EXPRESSED INSITU CONCRETE FRAME	BTH	BATH	
	LINEAL CLADDING SYSTEM, EXPRESSED JOINTS (PAINTED FIBRE CEMENT)	D ENS ENT	DINING ENSUITE	
	SHEET CLADDING SYSTEM, SET JOINTS (PAINTED FIBRE CEMENT)	G K	ENTRY GARAGE KITCHEN	
	ALUMINUM FRAMED WINDOWS (POWDER COATED FINISH)	L LDY	LIVING LAUNDRY	
)	ALUMINIUM FRAMED PRIVACY SLIDING SCREENS AND FIXED BLADES	T WIR POS	TERRACE (POS) WALK IN ROBE	NOTES
)	(POWDERCOAT FINISH) FACE BLOCKWORK	PU3	PRIVATE OPEN SPACE YARD	 REFER TO DRAWING DA/30 FOR E MATERIALS AND COLOURS.
)	CONCRETE FRAME FLOOR STRUCTURE			- REFER TO LANDSCAPE ARCHITEC
)	CONCRETE FRAME WALL STRUCTURE WITH LIGHT WEIGHT STUD INFILL FRAMES			FOR THE PROPOSED PLANTING. T PLANTING HAS NOT BEEN SHOWN
	CONCRETE ROOF STRUCTURE (GREEN ROOF OVER)			ARCHITECTURAL ELEVATIONS FO
)	PLASTERBOARD WALL & CEILING LINING			

LEGEND - MATERIALS & ROOM TYPES

R EXTERNAL BUILDING

ITECTS DOCUMENTATION
IG. THE FULL EXTENT OF
OWN ON THE
S FOR BUILDING CLARITY.

		REV.	Development Application DESCRIPTION	16.12.2019 DATE
VERIFY ALL DIMENSIONS ON SITE BEFORE CONSTRUCTION COMMENCES.				
USE FIGURED DIMENSIONS IN PREFERENCE TO SCALE.	□₩			
LEVELS SHOWN ON PLAN ARE APPROXIMATE ONLY AND SHALL BE VERIFIED ON SITE BEFORE CONSTRUCTION COMMENCES.				
THIS DRAWING ALWAYS REMAINS THE COPYRIGHT OF EDMISTON JONES GBB AND SHALL NOT BE USED OTHER THAN FOR THE PROJECT INTENDED WITHOUT WRITTEN AUTHORITY.	SION			
451) trading as EDMISTON JONES GBB © 2019	7			
COPYRIGHT OF TILMENT PTY LTD (ACN 003 163				

BUILDING 5

For Surewin Parkview Pty Ltd Proposed Residential Development THE COSGROVE At Lot 90 in D.P. 1086429, 14 Cosgrove Avenue, Keiraville, NSW, 2500
 WOLLONGONG
 NOWRA
 BATEMANS BAY


 T 02 4226 3600
 T 02 4421 6822
 T 02 4472 7388


W www.aej.com.au **E** aej@aej.com.au

DRAWING TITLE: Building 5 – Elevations & Section MFJ 16.12.2019 1:200 EJ PROJECT No:


17-0049

DA/20

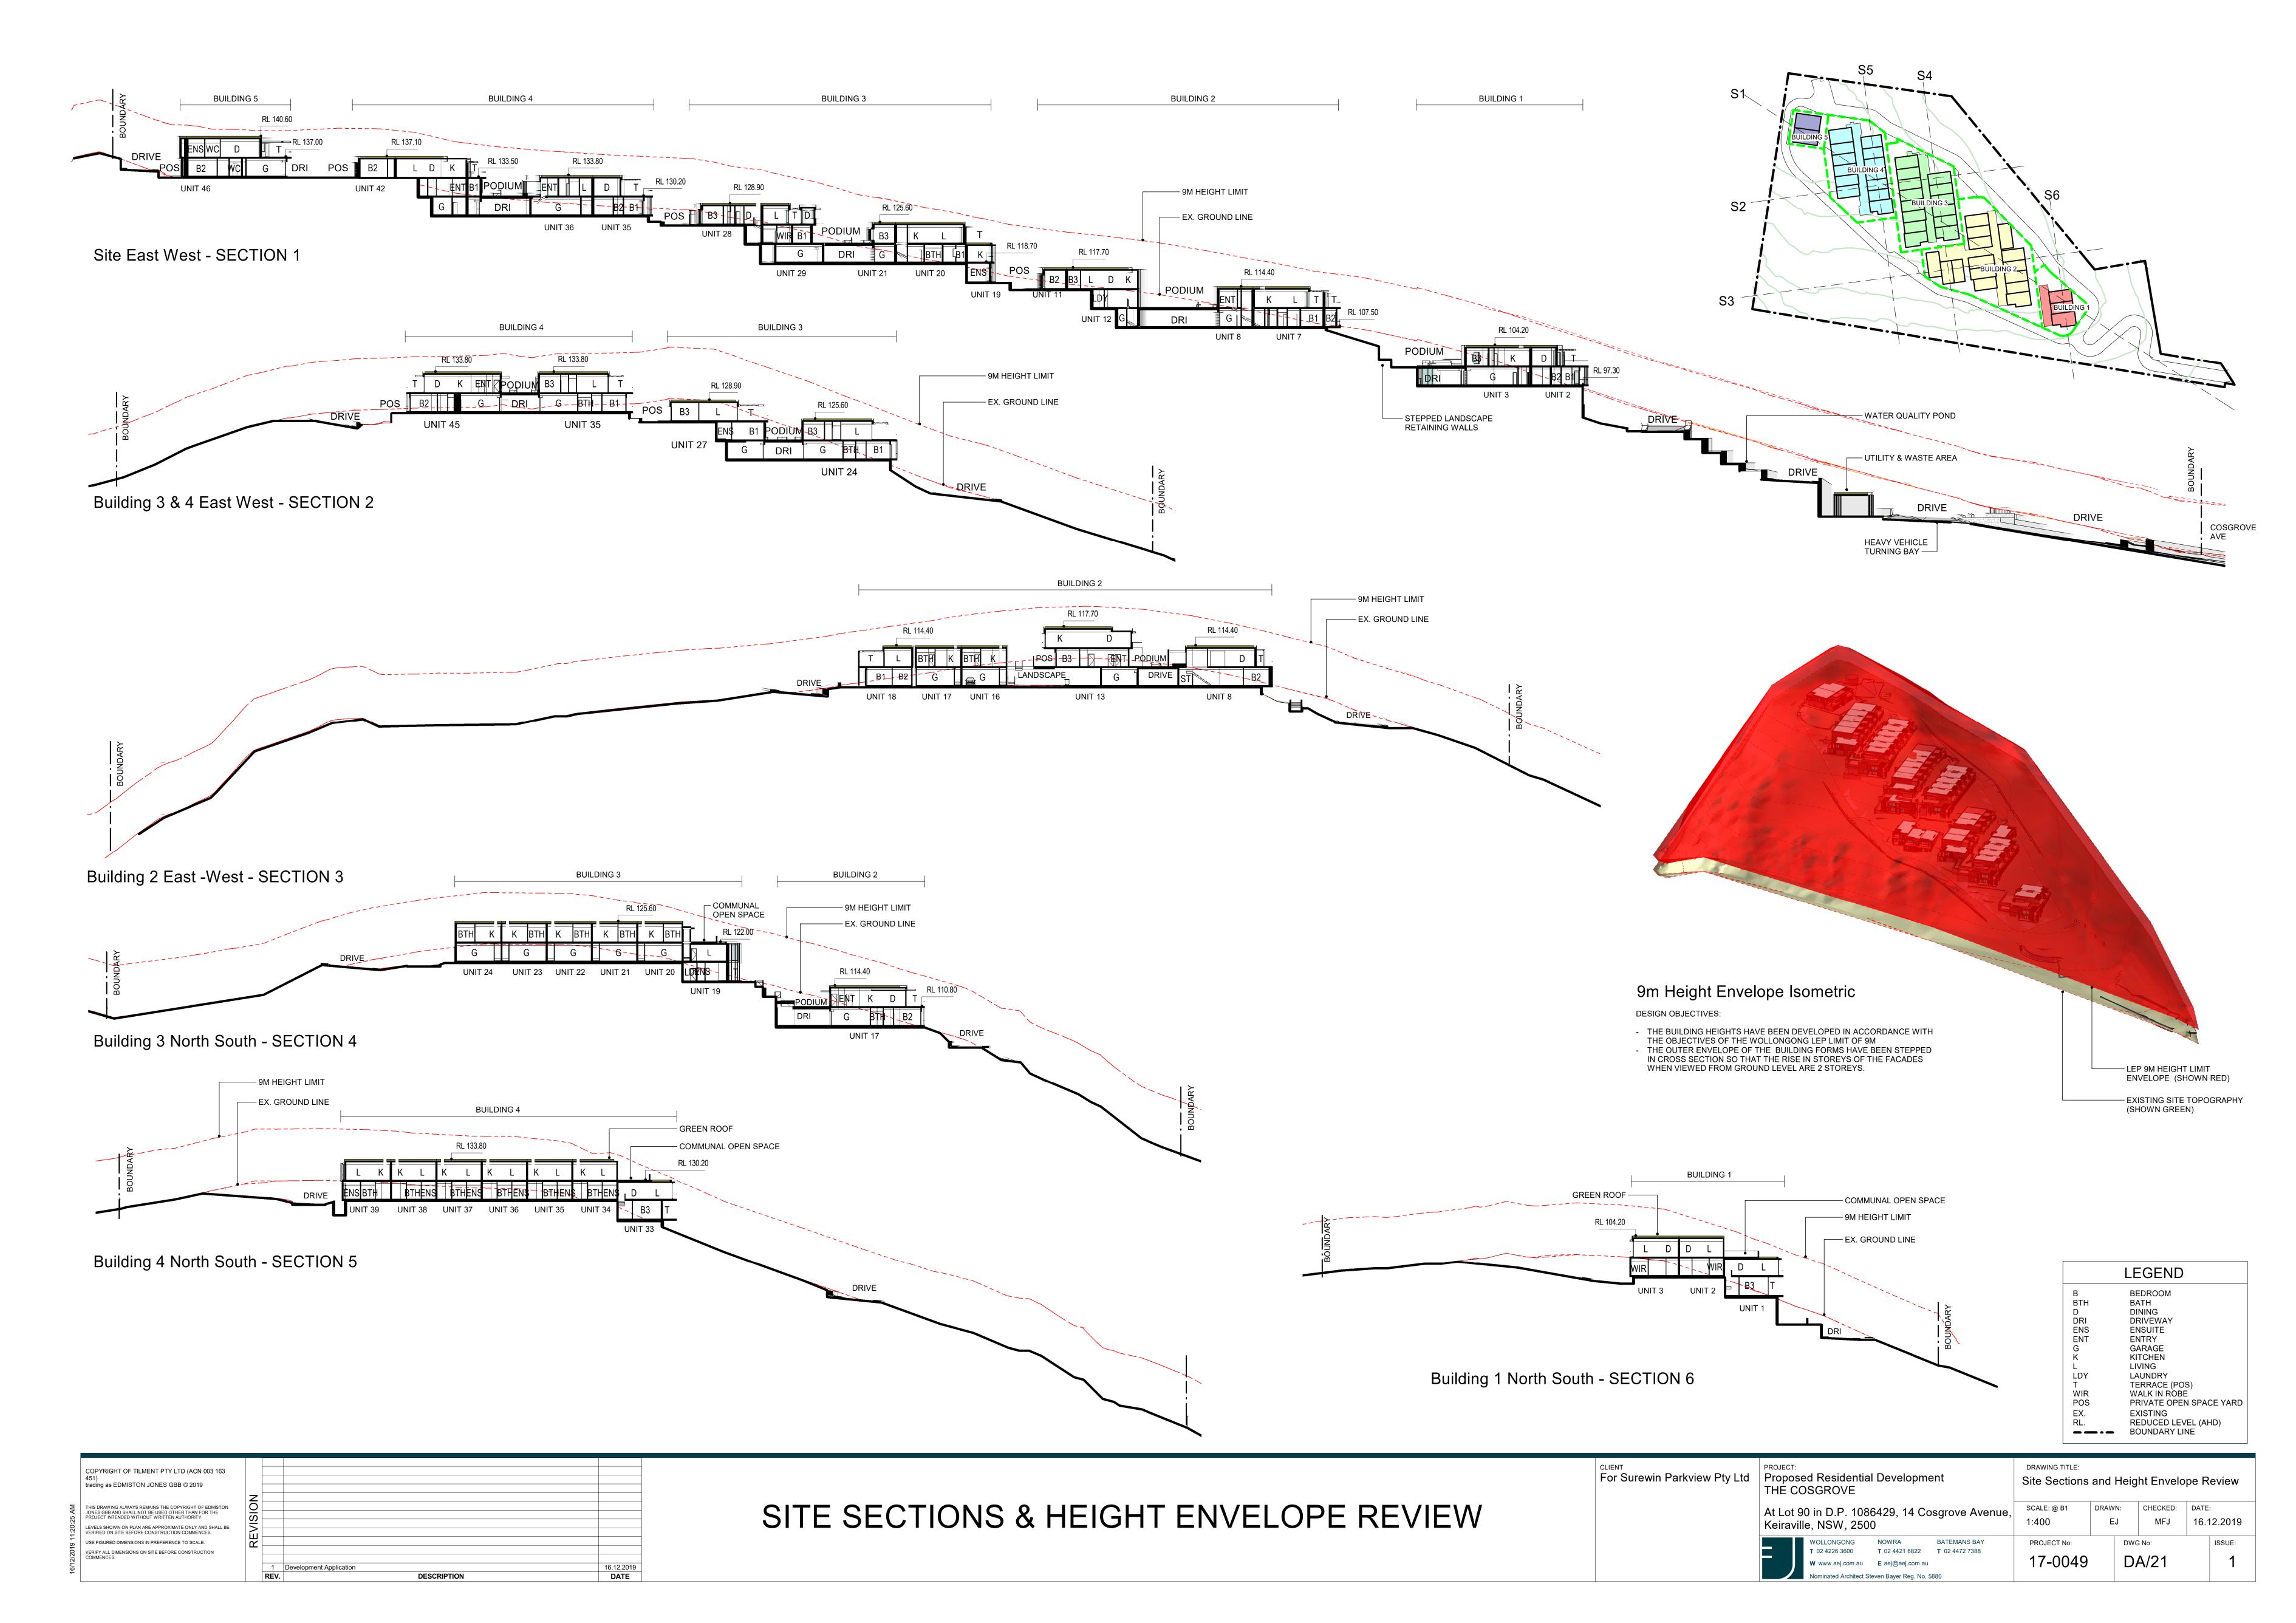

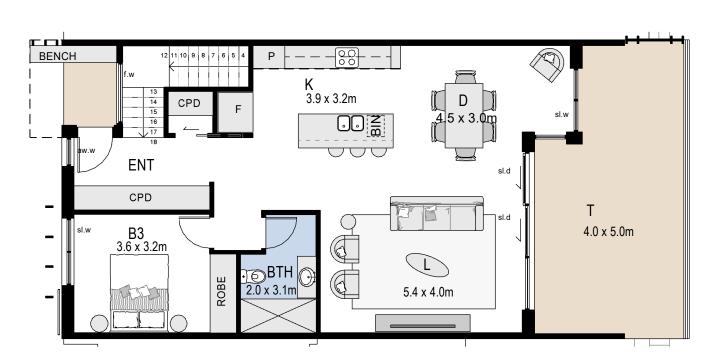


Type 1 Dwelling - Upper Ground (Podium)

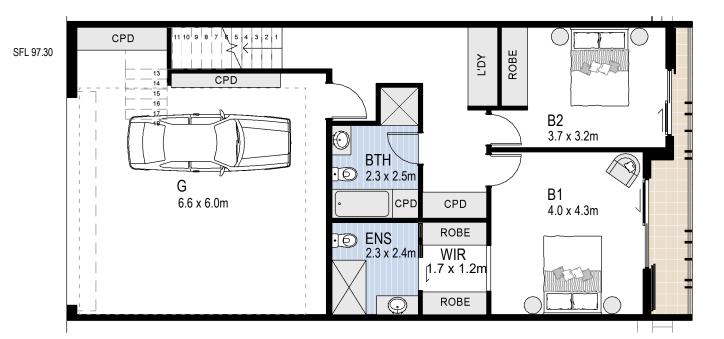


Type 1 Dwelling - Ground (Parking)


TYPE 1 DWEL	LING AREAS
Floor Area GFA	180 sqm
Garage	44 sqm
Terraces POS	38 sqm
Typical Total Area	262 sqm

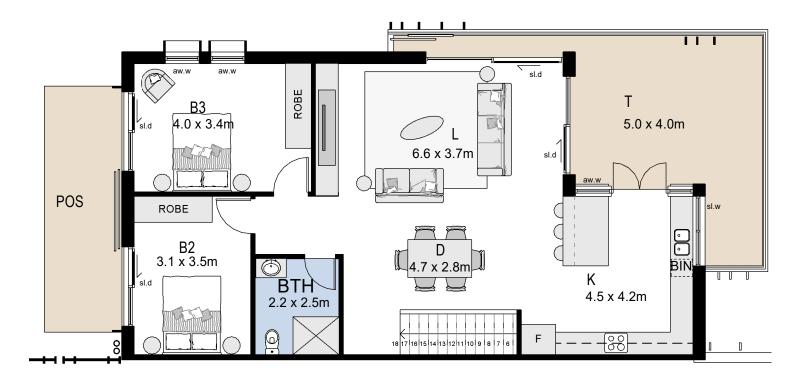

Type 5 Dwelling - Level 1.

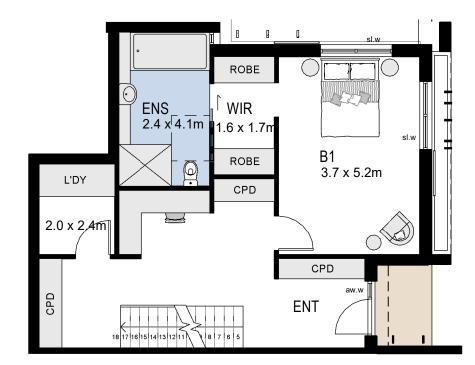


Type 5 Dwelling - Upper Ground (Podium)

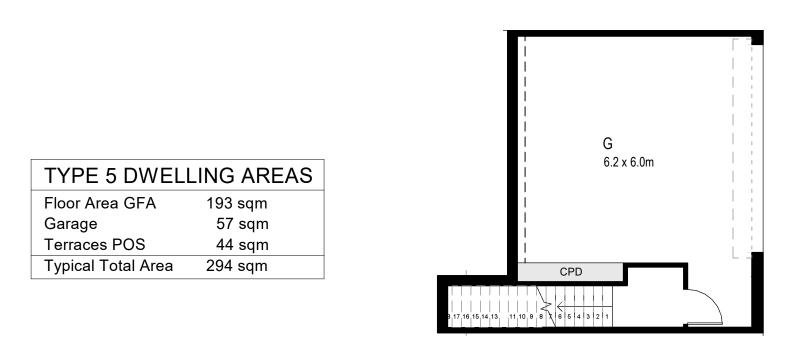


1 Development Application

Type 5 Dwelling - Ground (Parking)

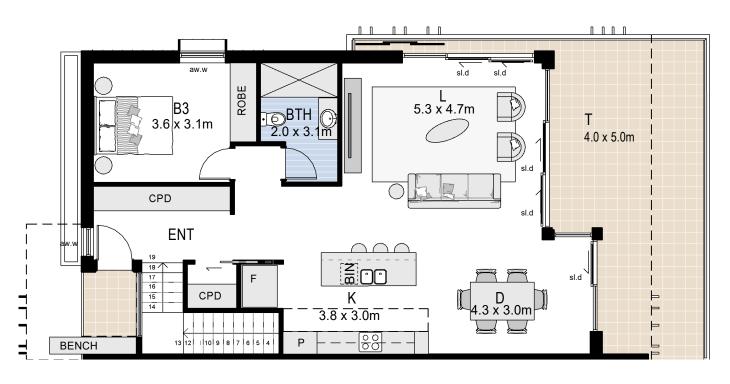


Type 2 Dwelling - Upper Ground (Podium)

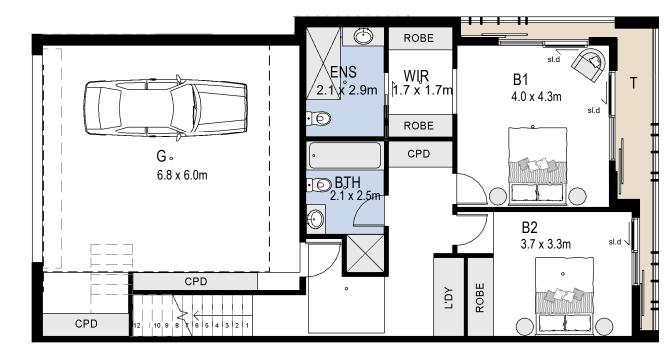


Type 2 Dwelling - Ground (Parking)


TYPE 2 DWEL	LING AREAS
Floor Area GFA	180 sqm
Garages	50 sqm
Terraces POS	48 sqm
Typical Total Area	278 sqm

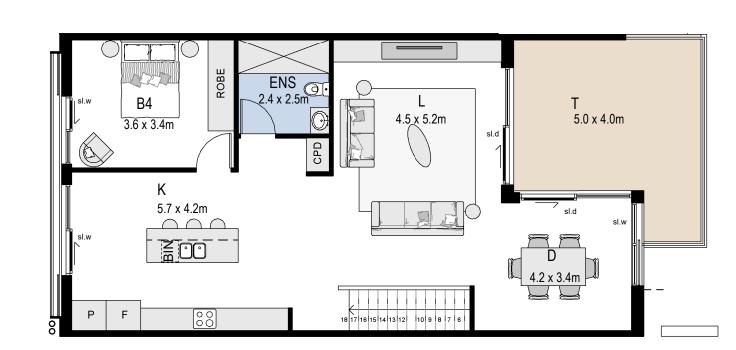

Type 6 Dwelling - Level 1

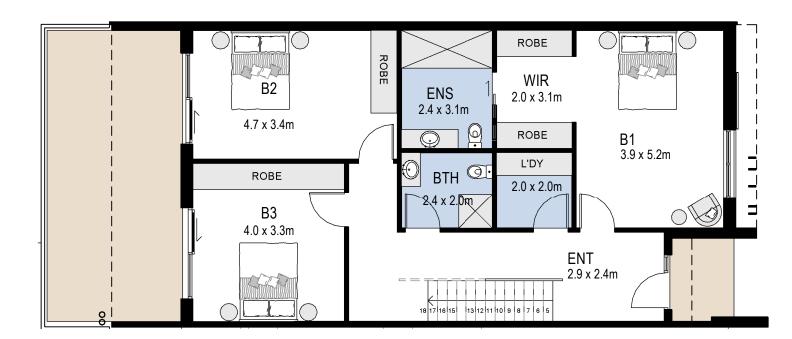


Type 6 Dwelling - Upper Ground (Podium)

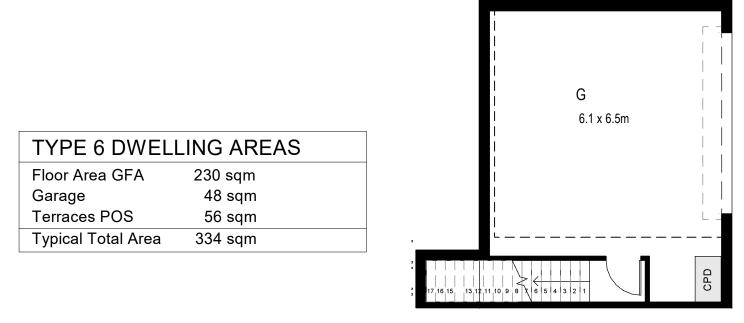


Type 6 Dwelling - Ground (Parking)

16.12.2019

DATE

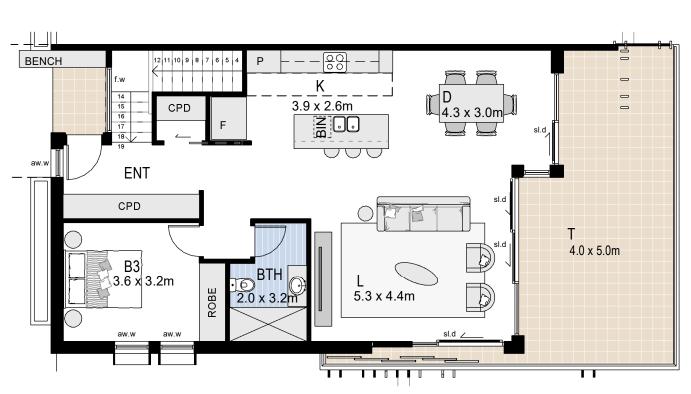


Type 3 Dwelling - Upper Ground (Podium)

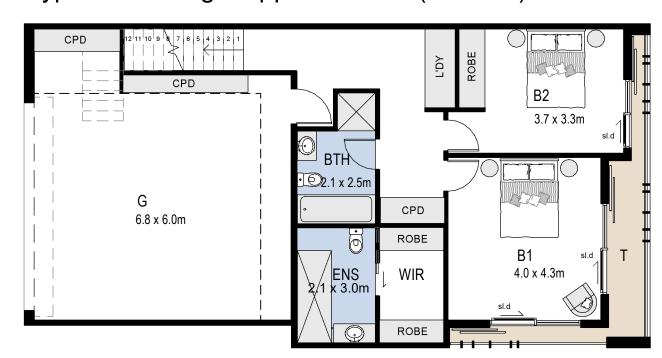


Type 3 Dwelling - Ground (Parking)


TYPE 3 DWELLING AREAS			
Floor Area GFA	172 sqm		
Garage	58 sqm		
Terraces POS	48 sqm		
Typical Total Area	278 sqm		

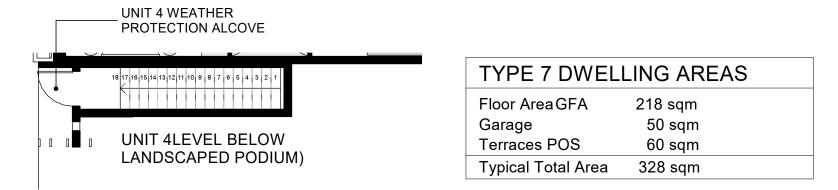


Type 7 Dwelling - Upper Ground (Podium)

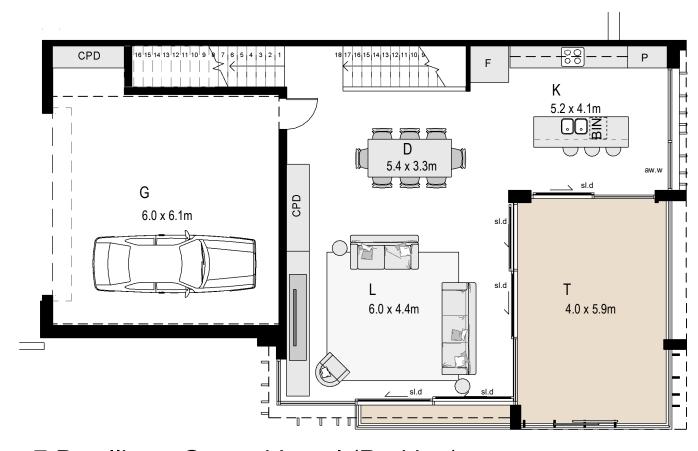


Type 7 Dwelling - Ground Level (Parking)

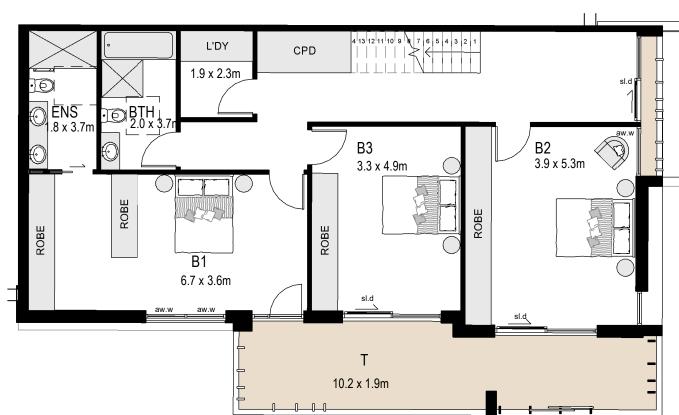


Type 7 Dwelling - Lower Ground

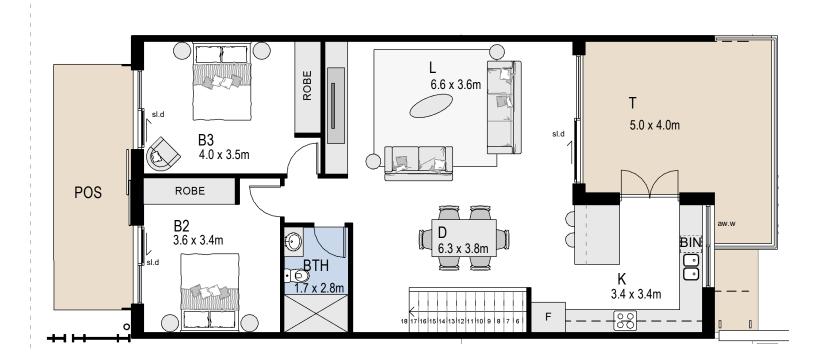

Type 4 Dwelling - Level 1

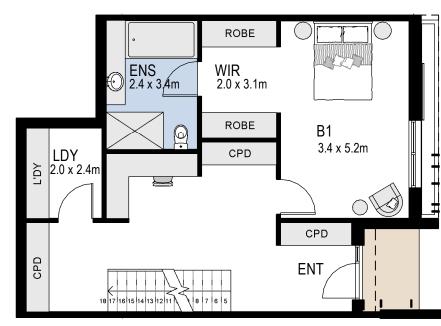

Type 4 Dwelling - Upper Ground (Podium)

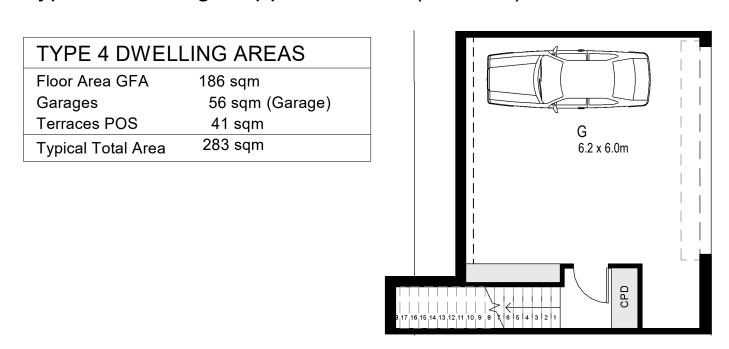

Type 4 Dwelling - Ground (Parking)

Dwelling Number / Dwelling Type / Building Location				Dwelling Number / Dwelling Type / Building Location			DWELLING TYPE SCHEDUL			
Dwelling No	Unit Type	Bldg No	Dwelling No	Unit Type	Bldg No	Dwelling Type	Description	Quaniti		
Unit 1	Type 7	Bldg 1	Unit 25	Type 5	Bldg 3					
Unit 2	Type 1	Bldg 1	Unit 26	Type 4	Bldg 3	Type 1	Three Bedroom	15		
Unit 3	Type 2	Bldg 1	Unit 27	Type 4	Bldg 3	Type 2	Three Bedroom	6		
Unit 4	Type 7	Bldg 2	Unit 28	Type 4	Bldg 3	Type 3	Three Bedroom	1		
Unit 5	Type 1	Bldg 2	Unit 29	Type 6	Bldg 3	Type 4	Three Bedroom	7		
Unit 6	Type 1	Bldg 2	Unit 30	Type 6	Bldg 3	Type 5	Three Bedroom	2		
Unit 7	Type 1	Bldg 2	Unit 31	Type 1	Bldg 3	Type 6	Four Bedroom	6		
Unit 8	Type 2	Bldg 2	Unit 32	Type 8	Bldg 3	Type 7	Three Bedroom	4		
Unit 9	Type 12	Bldg 2	Unit 33	Type 7	Bldg 4	Type 8	Three Bedroom	1		
Unit 10	Type 5	Bldg 2	Unit 34	Type 1	Bldg 4	Type 9	Four Bedroom	1		
Unit 11	Type 4	Bldg 2	Unit 35	Type 1	Bldg 4	Type 10	Four Bedroom	1		
Unit 12	Type 4	Bldg 2	Unit 36	Type 1	Bldg 4	Type 11	Four Bedroom	1		
Unit 13	Type 6	Bldg 2	Unit 37	Type 1	Bldg 4	Type 12	Four Bedroom	2		
Unit 14	Type 6	Bldg 2	Unit 38	Type 1	Bldg 4					
Unit 15	Type 2	Bldg 2	Unit 39	Type 2	Bldg 4					
Unit 16	Type 1	Bldg 2	Unit 40	Type 9	Bldg 4					
Unit 17	Type 3	Bldg 2	Unit 41	Type 4	Bldg 4					
Unit 18	Type 12	Bldg 2	Unit 42	Type 4	Bldg 4					
Unit 19	Type 7	Bldg 3	Unit 43	Type 6	Bldg 4					
Unit 20	Type 1	Bldg 3	Unit 44	Type 6	Bldg 4					
Unit 21	Type 1	Bldg 3	Unit 45	Type 2	Bldg 4					
Unit 22	Type 1	Bldg 3	Unit 46	Type 11	Bldg 5					
Unit 23	Type 1	Bldg 3	Unit 47	Type 10	Bldg 5					
Unit 24	Type 2	Bldg 3	•	•						

FLOOR FINISHES					
ROOM ABBREVIATION	ROOM TYPE	FLOOR FINISH			
B BTH D ENS ENT G K L LDY T WIR	BEDROOM BATH DINING ENSUITE ENTRY GARAGE KITCHEN LIVING LAUNDRY TERRACE WALK IN ROBE	CARPET TILE TIMBER TILE TILE CONCRETE TIMBER TIMBER TILE TILE TILE CARPET			

B BEDROOM BTH BATH D DINING ENS ENSUITE ENT ENTRY G GARAGE K KITCHEN L LIVING LDY LAUNDRY T TERRACE (POS) WIR WALK IN ROBE POS PRIVATE OPEN SPACE YARD RL REDUCE LEVEL (AHD)

NOTES

REFER TO ARCHITECTURAL DRAWING DA/04 FOR DWELLING TYPOLOGY LOCATION SITE PLAN
 REFER TO 1:200 FLOOR PLANS FOR PRIVACY CONTROL
 INDOOR WASTE RECYCLING CUPBOARDS LOCATED WITHIN KITCHEN CUPBOARDS AD JACENT TO SINK

COPYRIGHT OF TILMENT PTY LTD (ACN 003 163 451)
trading as EDMISTON JONES GBB © 2019

THIS DRAWING ALWAYS REMAINS THE COPYRIGHT OF EDMISTON JONES GBB AND SHALL NOT BE USED OTHER THAN FOR THE PROJECT INTENDED WITHOUT WRITTEN AUTHORITY.

LEVELS SHOWN ON PLAN ARE APPROXIMATE ONLY AND SHALL BE VERIFIED ON SITE BEFORE CONSTRUCTION COMMENCES.

USE FIGURED DIMENSIONS IN PREFERENCE TO SCALE.

VERIFY ALL DIMENSIONS ON SITE BEFORE CONSTRUCTION
COMMENCES.

DESCRIPTION


For Surewin Parkview Pty Ltd

Ltd	PROJECT: Proposed Residential Development						
	THE COSGROVE						
	At Lot 90 in D.P. 1086429, 14 Cosgrove Avenue, Keiraville, NSW, 2500						
	WOLLONGONG NOWDA DATEMANS DAY	_					


T 02 4421 6822 T 02 4472 7388

02 4226 3600


1		3	4	5	6	7	8	9			
	Drawing Title: Dwelling Typologies Sheet 1 of 2										
ıe,	SCALE: @ B1 1:100	DRAW		CHECKEI MFJ	D:	DATE:	2.20	19			
	PROJECT No: 17-0049		DWG No:				ISSUE	 :: 1			
	11-0043							•			

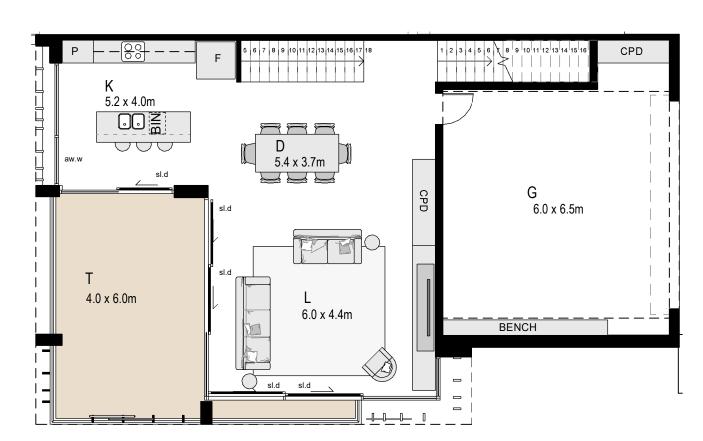


Type 8 Dwelling - Ground (Parking)

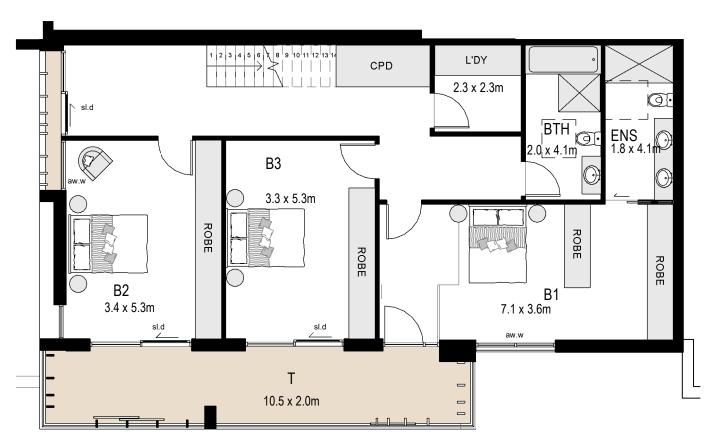


Type 8 Dwelling - Lower Ground

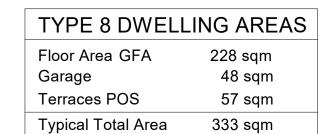


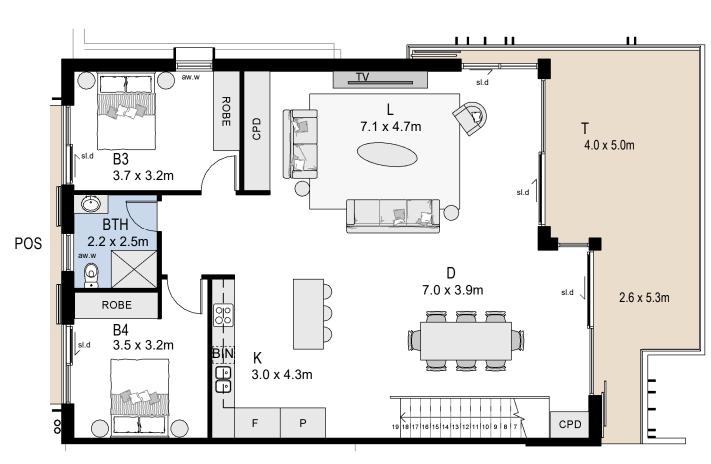


Type 9 Dwelling - Level 1

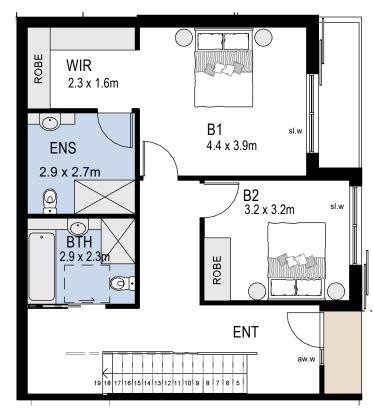


Type 9 Dwelling - Upper Ground (Podium)

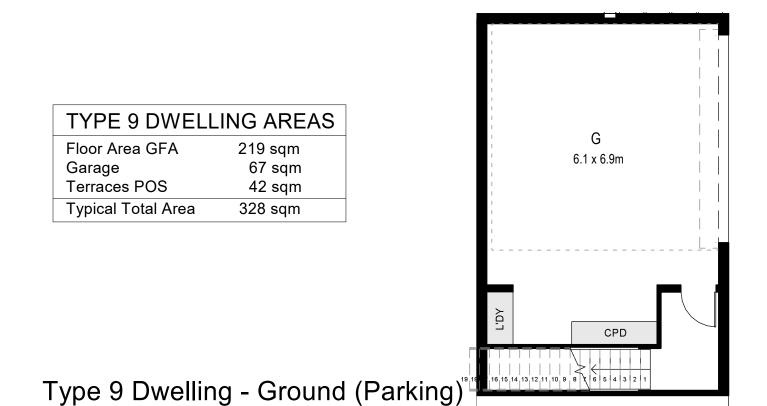

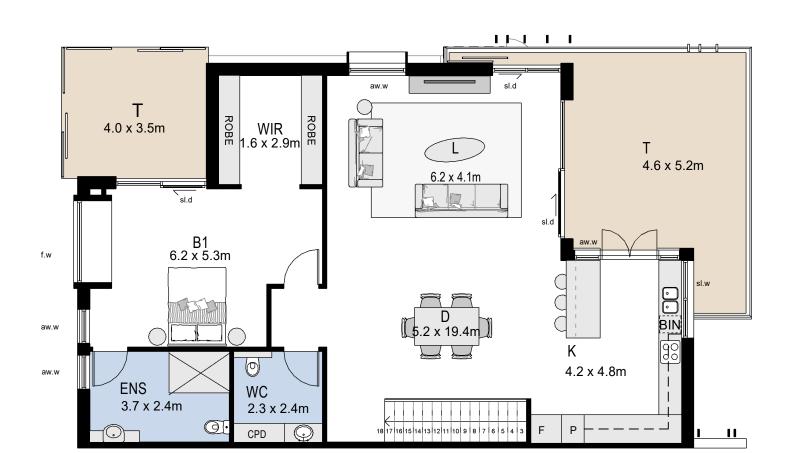


Type 10 Dwelling - Level L1

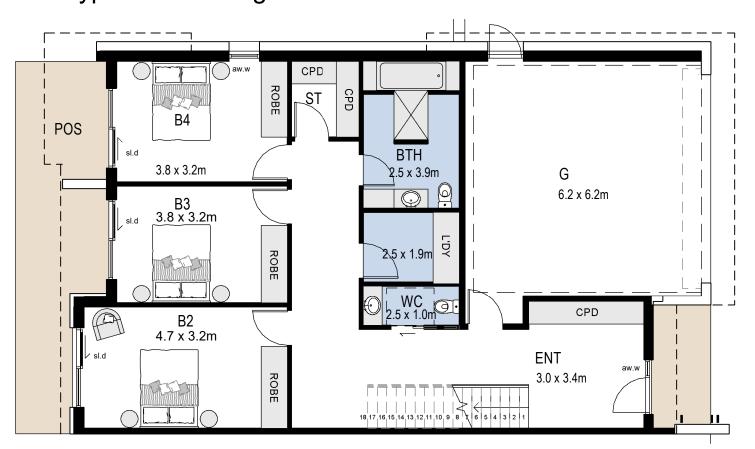


Type 10 Dwelling - Ground (Parking)

TYPE 10 DWELLING ARE				
Floor Area GFA	252 sqm			
Garage	44 sqm			
Terraces POS	57 sqm			
Typical Total Area	353 sqm			

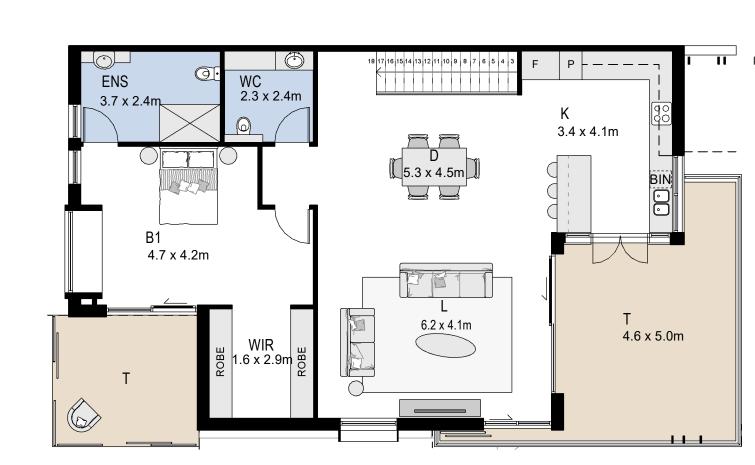


Type 11 Dwelling - Level 1

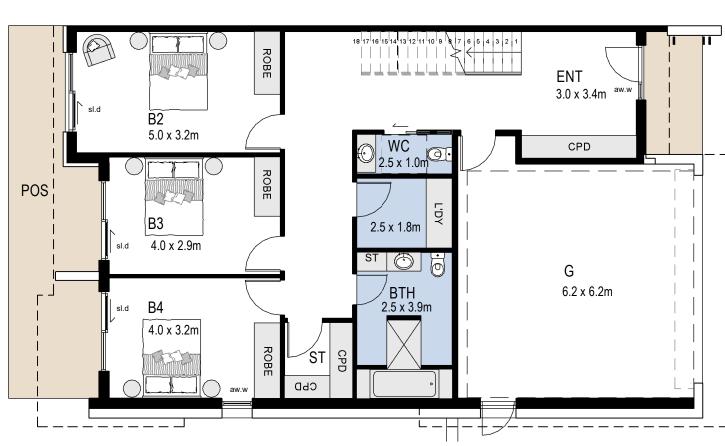

Type 11 Dwelling - Ground (Parking)

TYPE 11 DWELLING AREAS					
Floor Area GFA	252 sqm				
Garage	44 sqm				
Terraces POS	57 sqm				
Typical Total Area	353 sqm				

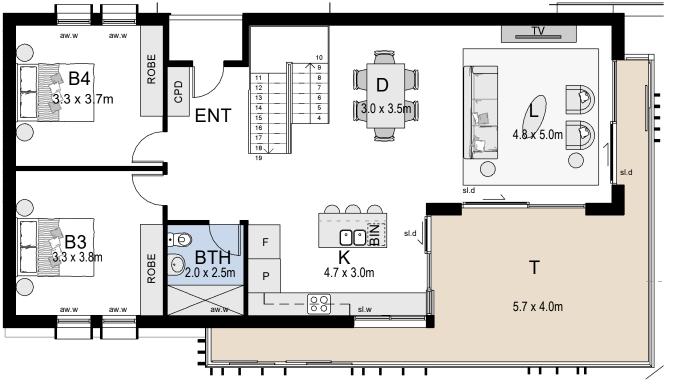

Type 12 Dwelling - Upper Ground (Podium)



TYPE 12 DWELL	LING AREAS	
Floor Area GFA	198 sqm	
Garage	53 sqm	
Terraces POS	53 sqm	
Typical Total Area	304 sqm	

16.12.2019

|Dwelling Number / Dwelling Type / | Dwelling Number / Dwelling Type / | Type 4 Unit 32 Unit 36 Bldg 4 Unit 40 Type 3 Unit 43 Unit 45 Unit 46 Unit 47 Unit 23 Type 1 Type 10

Dwelling Type	Description	Quanitiy
Type 1	Three Bedroom	15
Type 2	Three Bedroom	6
Type 3	Three Bedroom	1
Type 4	Three Bedroom	7
Type 5	Three Bedroom	2
Type 6	Four Bedroom	6
Type 7	Three Bedroom	4
Type 8	Three Bedroom	1
Type 9	Four Bedroom	1
Type 10	Four Bedroom	1
Type 11	Four Bedroom	1
Type 12	Four Bedroom	2

_					
	DWELLING TYPE No	GFA m²	GARAGE m²	TERRACE m²	TOTAL m²
	Type 1	180	44	38	262
	Type 2	180	50	48	278
_	Type 3	172	58	48	278
	Type 4	186	56	41	283
	Type 5	193	57	44	294
-	Type 6	230	48	56	334
	Type 7	218	50	60	328
-	Type 8	228	48	57	333
	Type 9	219	67	42	328
-	Type 10	252	44	57	353
	Type 11	252	44	57	353
	Type 12	198	53	53	304

FLOOR FINISHES							
ROOM ABBREVIATION	ROOM TYPE	FLOOR FINISH					
B BTH D ENS ENT G K L LDY T WIR	BEDROOM BATH DINING ENSUITE ENTRY GARAGE KITCHEN LIVING LAUNDRY TERRACE WALK IN ROBE	CARPET TILE TIMBER TILE TILE CONCRETE TIMBER TIMBER TILE TILE TILE CARPET					

Type 12 Dwelling - Ground (Parking)

71	,	37	
COPYRIGHT OF TILMENT PTY LTD (ACN 003 163			
451) trading as EDMISTON JONES GBB © 2019			
•	_		
THIS DRAWING ALWAYS REMAINS THE COPYRIGHT OF EDMISTON	Ó		
JONES GBB AND SHALL NOT BE USED OTHER THAN FOR THE PROJECT INTENDED WITHOUT WRITTEN AUTHORITY.	S		
LEVELS SHOWN ON PLAN ARE APPROXIMATE ONLY AND SHALL BE	\leq		
VERIFIED ON SITE BEFORE CONSTRUCTION COMMENCES. USE FIGURED DIMENSIONS IN PREFERENCE TO SCALE.	Щ		
VERIFY ALL DIMENSIONS ON SITE BEFORE CONSTRUCTION	2		
COMMENCES.			


DESCRIPTION


DWELLING TYPOLOGY LOCATION SITE PLAN REFER TO 1:200 FLOOR PLANS FOR PRIVACY CONTROLS - INDOOR WASTE RECYCLING CUPBOARDS LOCATED WITHIN KITCHEN CUPBOARDS ADJACENT TO SINK 1 0 1 2 3 4 5 6 7 8 9


NOTES

- REFER TO ARCHITECTURAL DRAWING DA/04 FOR

For Surewin Parkview Pty Ltd		ed Residentia OSGROVE	Dwelling Typologies Sheet 2 of 2							
		90 in D.P. 108 lle, NSW, 250	=	osgrove Avenue,	SCALE: @ B1 1:100	DRAW E		CHECKED: MFJ	16.1	2.2019
	=	WOLLONGONG T 02 4226 3600 W www.aei.com.au	NOWRA T 02 4421 6822 E aei@aei.com.au	BATEMANS BAY T 02 4472 7388	PROJECT No: 17-0049		DWG	No:		ISSUE:

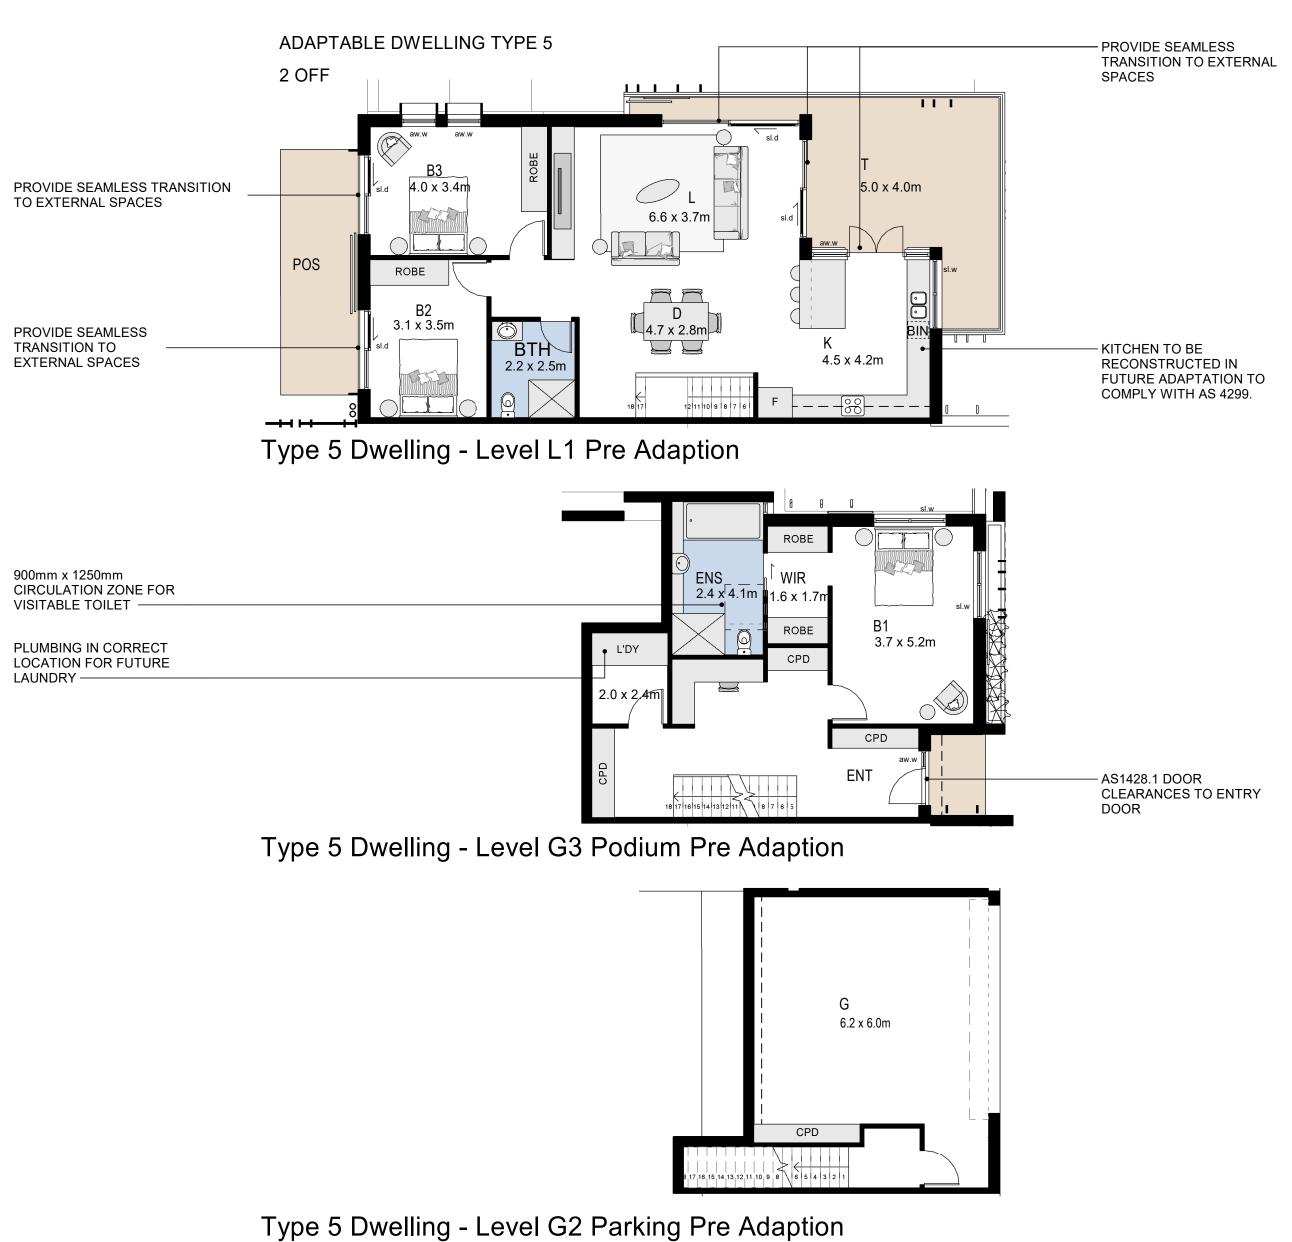

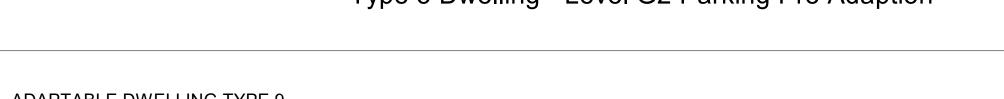

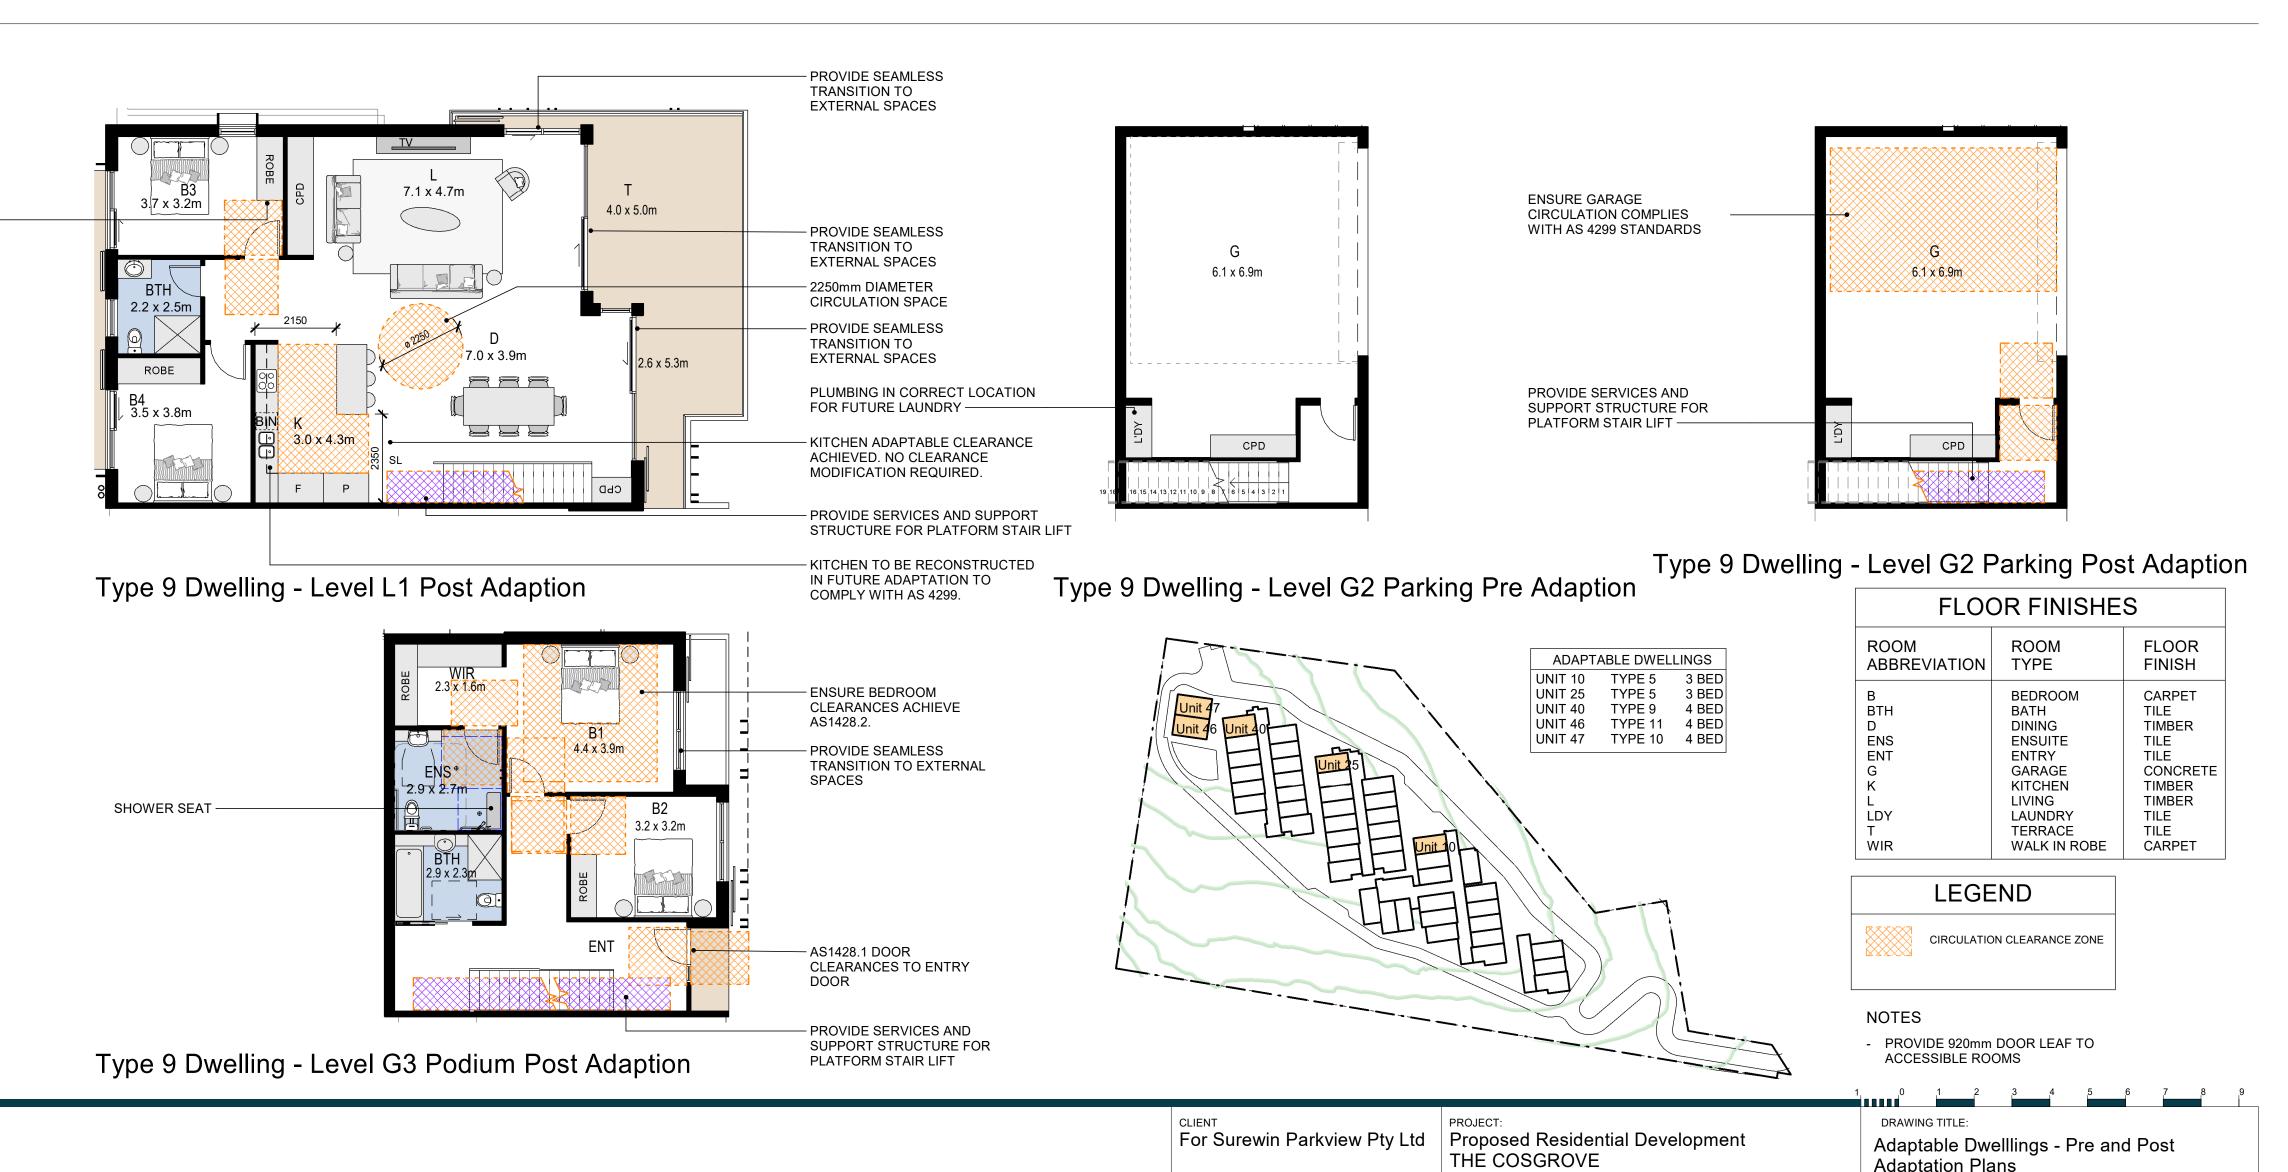

6.6 x 3.7m

Type 5 Dwelling - Level L1 Post Adaption

Type 5 Dwelling - Level G3 Podium Post Adaption

Type 5 Dwelling - Level G2 Parking Post Adaption

4.0 x 3.4m

ROBE

PROVIDE SEAMLESS

EXTERNAL SPACES -

PROVIDE SEAMLESS

SHOWER SEAT -

ADAPTABLE DWELLINGS

PROVIDE SERVICES AND SUPPORT STRUCTURE FOR PLATFORM STAIR LIFT ——

TRANSITION TO EXTERNAL SPACES

MODIFY ROBES FOR DOOR

CIRCULATION CLEARANCES

TRANSITION TO

PROVIDE SEAMLESS
TRANSITION TO

EXTERNAL SPACES

- 2250mm DIAMETER

CIRCULATION SPACE

PROVIDE SEAMLESS

EXTERNAL SPACES

KITCHEN ADAPTABLE CLEARANCE ACHIEVED. NO CLEARANCE MODIFICATION

TRANSITION TO

REQUIRED.

- KITCHEN TO BE

RECONSTRUCTED IN

- ENSURE BEDROOM

TO ENTRY DOOR

AS1428.2.

CLEARANCES ACHIEVE

- AS1428.1 DOOR CLEARANCES

- ENSURE GARAGE CIRCULATION

COMPLIES WITH AS 4299

SUPPORT STRUCTURE FOR

CHECKED: DATE:

MFJ

DA/24

PROJECT No:

17-0049

16.12.2019

ISSUE:

PLATFORM STAIR LIFT

At Lot 90 in D.P. 1086429, 14 Cosgrove Avenue

W www.aej.com.au E aej@aej.com.au

T 02 4421 6822 T 02 4472 7388

Keiraville, NSW, 2500

VOLLONGONG

02 4226 3600

STANDARDS

FUTURE ADAPTATION TO

PROVIDE SERVICES AND

SUPPORT STRUCTURE FOR PLATFORM STAIR LIFT

COMPLY WITH AS 4299.

111


TERRACE

5.0 x 4.0m

 $3.7 \times 5.2 \text{m}$

6.2 x 6.0m

CPD

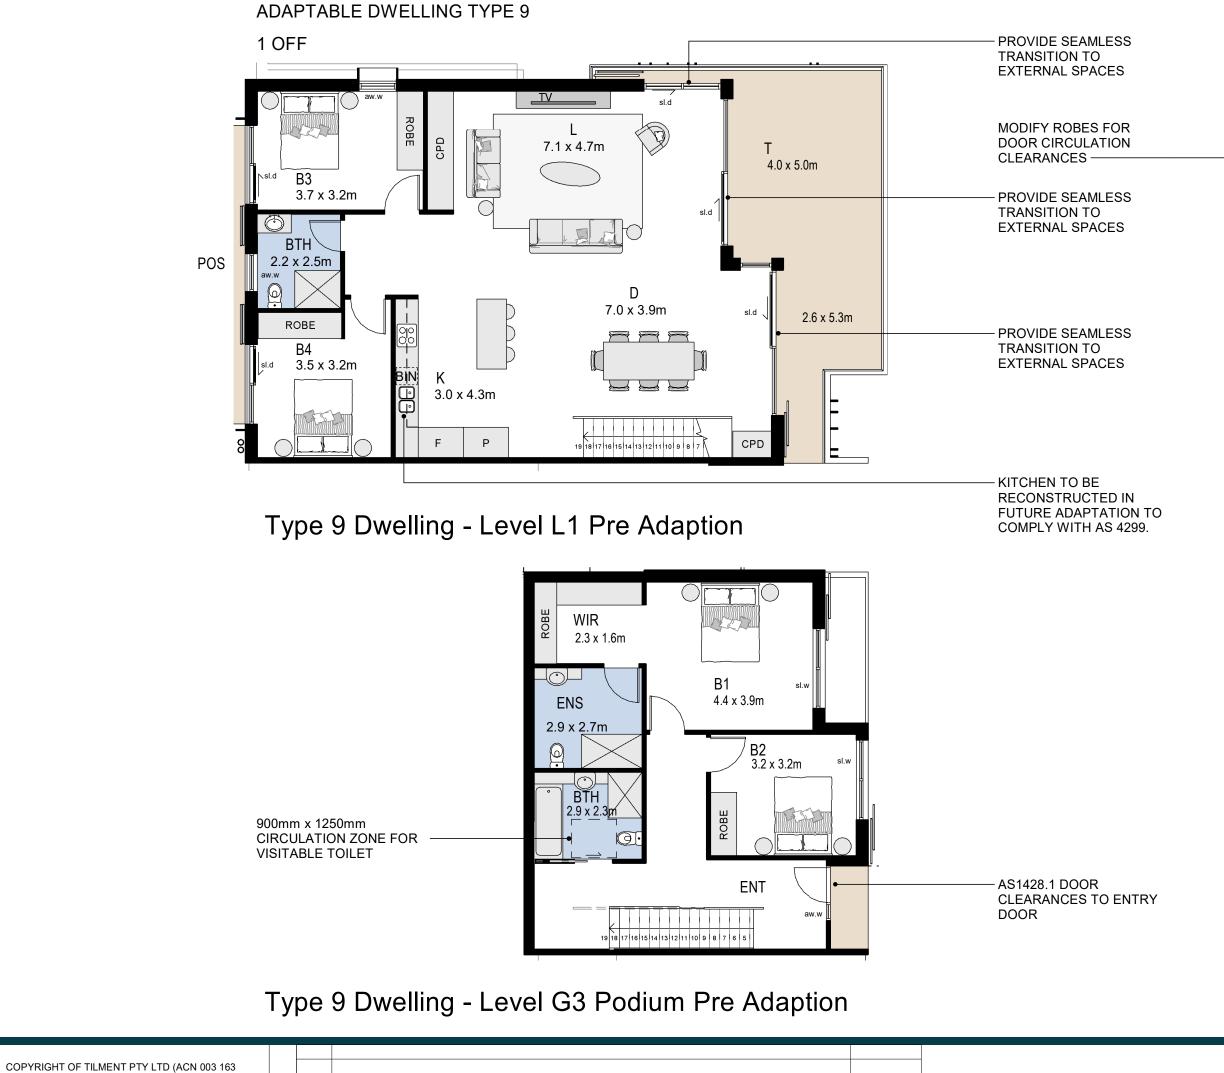

16.12.2019

DATE

trading as EDMISTON JONES GBB © 2019

LEVELS SHOWN ON PLAN ARE APPROXIMATE ONLY AND SHALL BE VERIFIED ON SITE BEFORE CONSTRUCTION COMMENCES.

USE FIGURED DIMENSIONS IN PREFERENCE TO SCALE.

Development Application

DESCRIPTION

VERIFY ALL DIMENSIONS ON SITE BEFORE CONSTRUCTION COMMENCES.












Shadow Diagram June 21 10am Existing Topography



Shadow Diagram June 21 11am Existing Topography

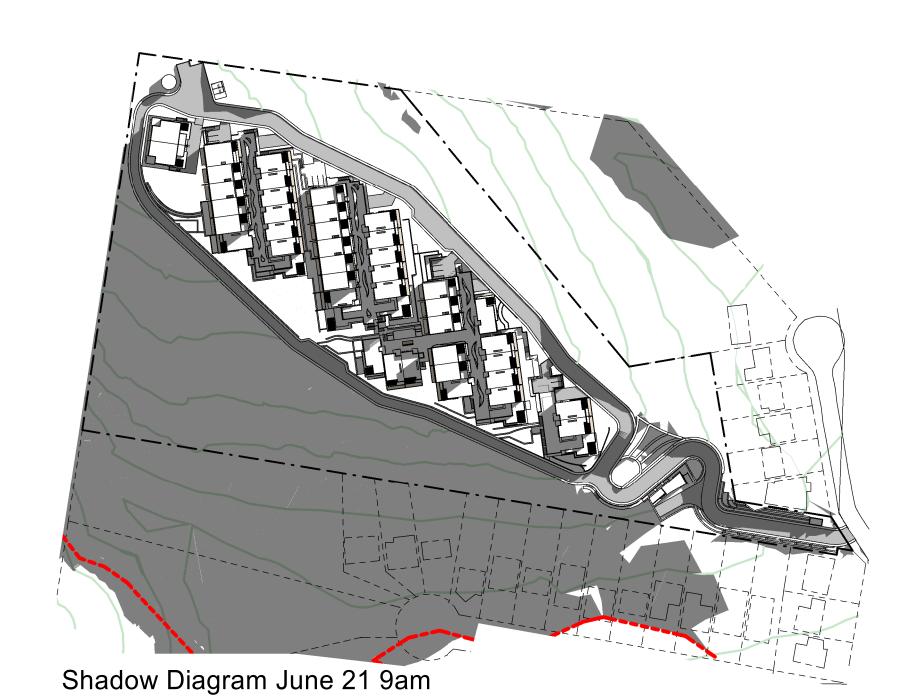

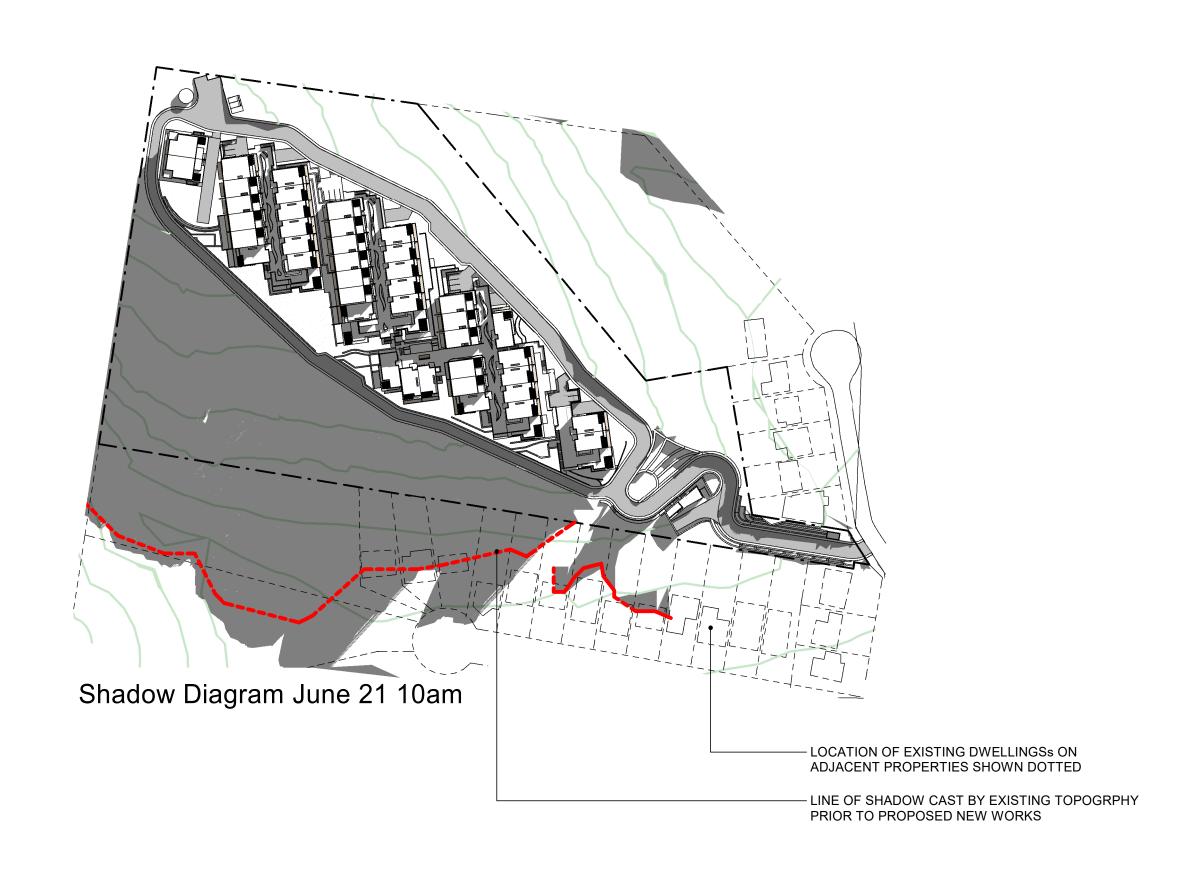

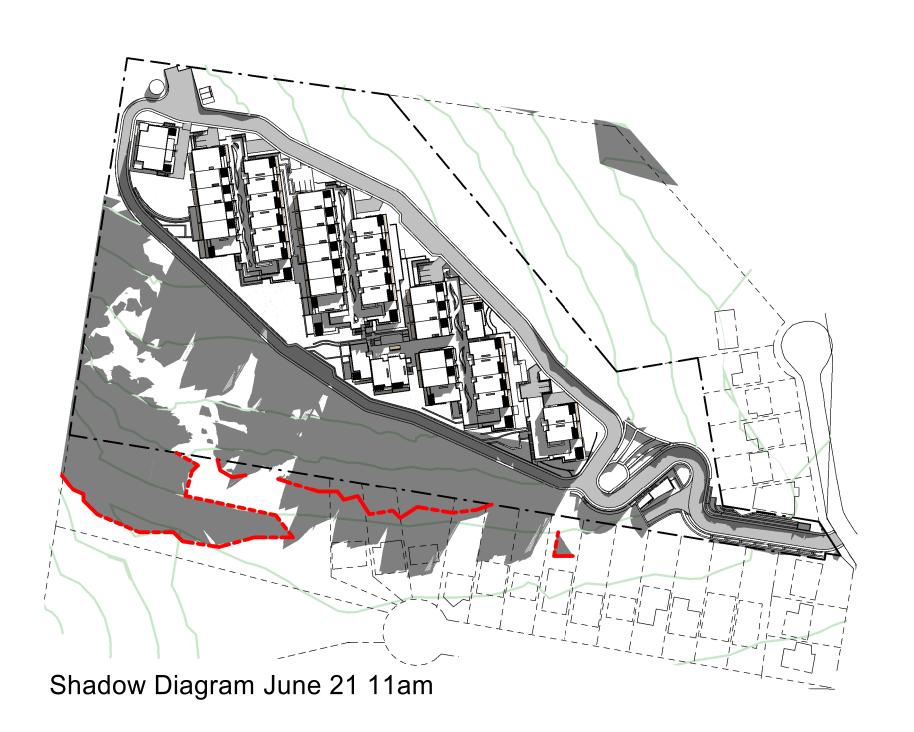


LEGEND


LINE OF SHADOW CAST BY EXISTING TOPOGRPHY PRIOR TO PROPOSED NEW WORKS

NOTES

- SHADOW CASTING DOES NOT INCLUDE SHADOWS CAST BY THE EXISTING VEGETATION OR EXISTING STRUCTURES ON ADJACENT PROPERTIES

DA/26

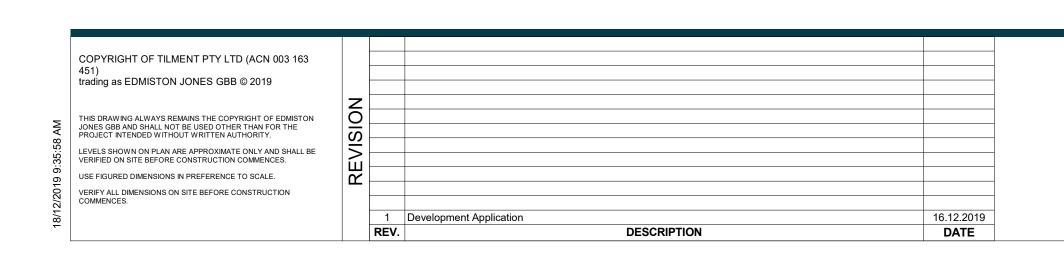

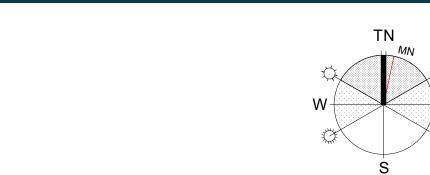

For Surewin Parkview Pty Ltd
For Surewin Parkview Pty Ltd

Proposed Residential Development THE COSGROVE	
At Lot 90 in D.P. 1086429, 14 Cosgrove Ave	enu


	90 in D.P. 108 ville, NSW, 250	· ·	osgrove Aver	ıu
_	WOLLONGONG T 02 4226 3600	NOWRA T 02 4421 6822	BATEMANS BAY T 02 4472 7388	


Nominated Architect Steven Bayer Reg. No. 5880


W www.aej.com.au **E** aej@aej.com.au


	DRAWING TITLE: Site Shadow Diagrams Sheet 1 of 2					
venue,	SCALE: @ B1	DRAWN:		CHECKED:	DATE:	
veriue,	1:1750	EJ		MFJ	16.12.2019	
AY 8	PROJECT No:		DWG	S No:		ISSUE:



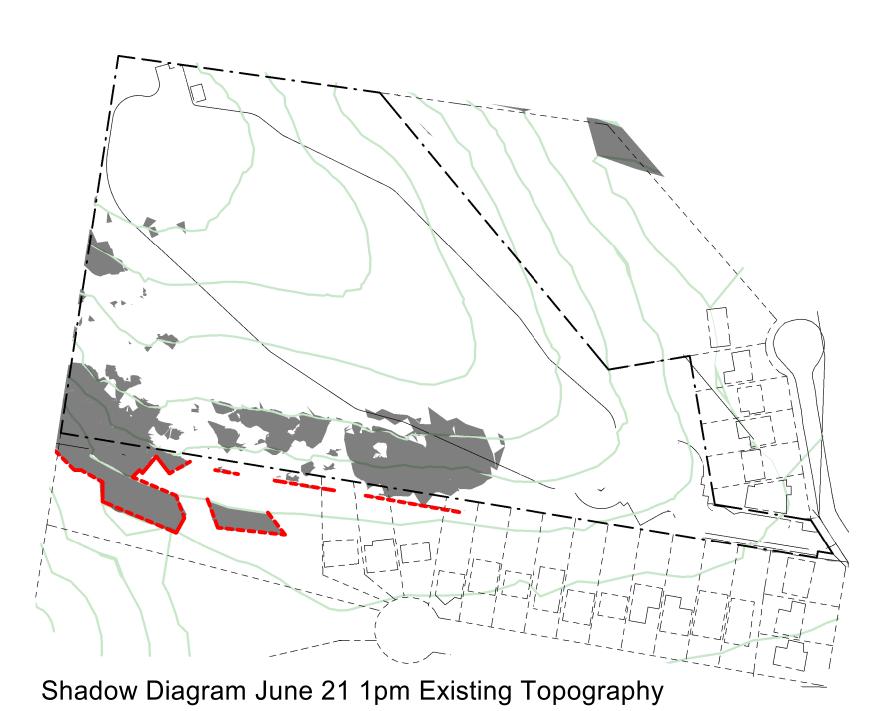

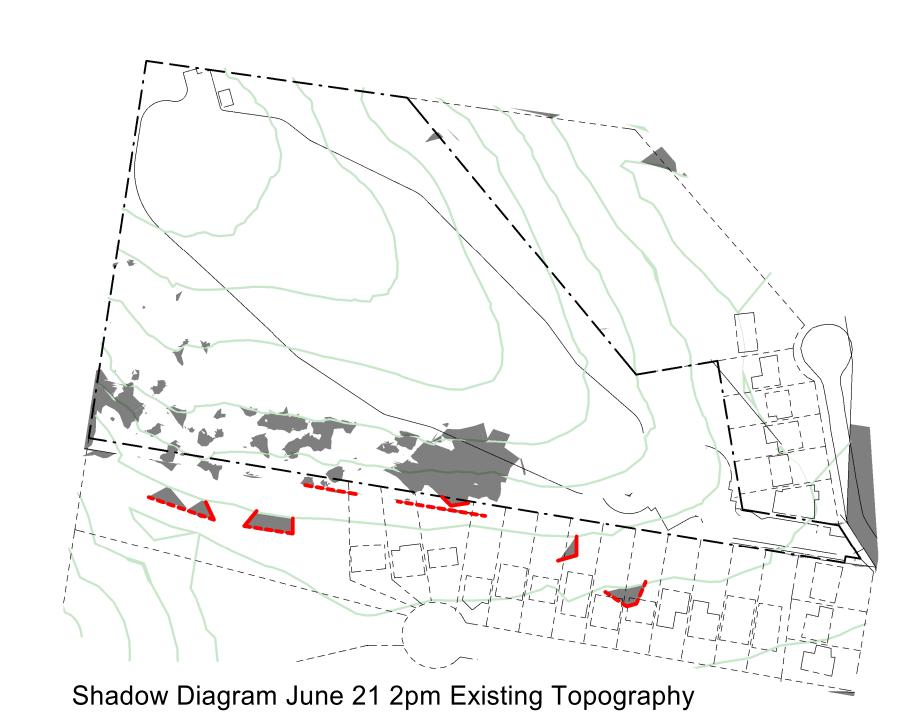

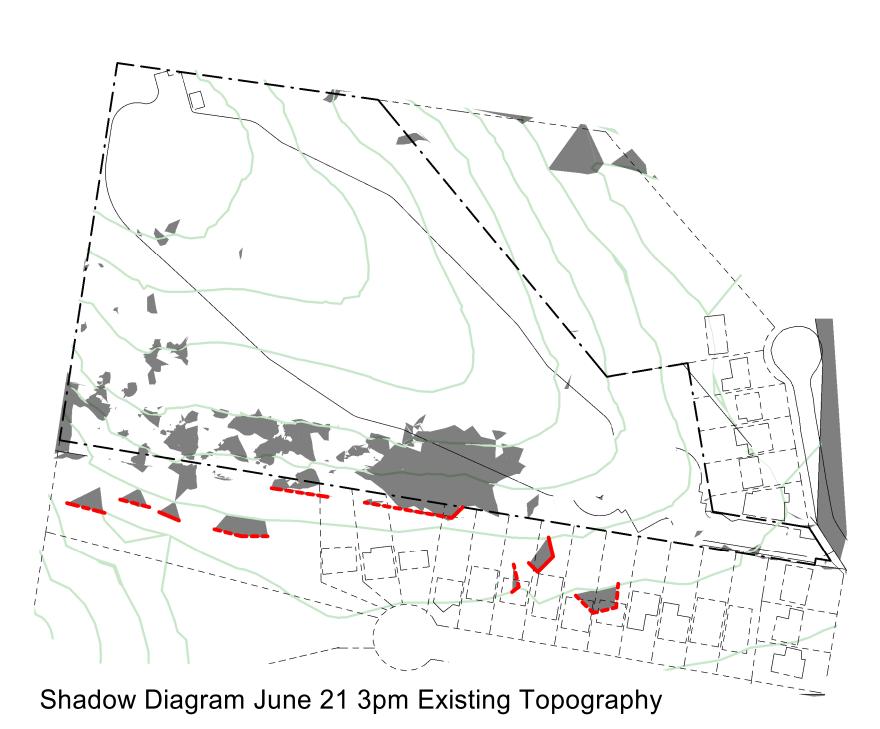

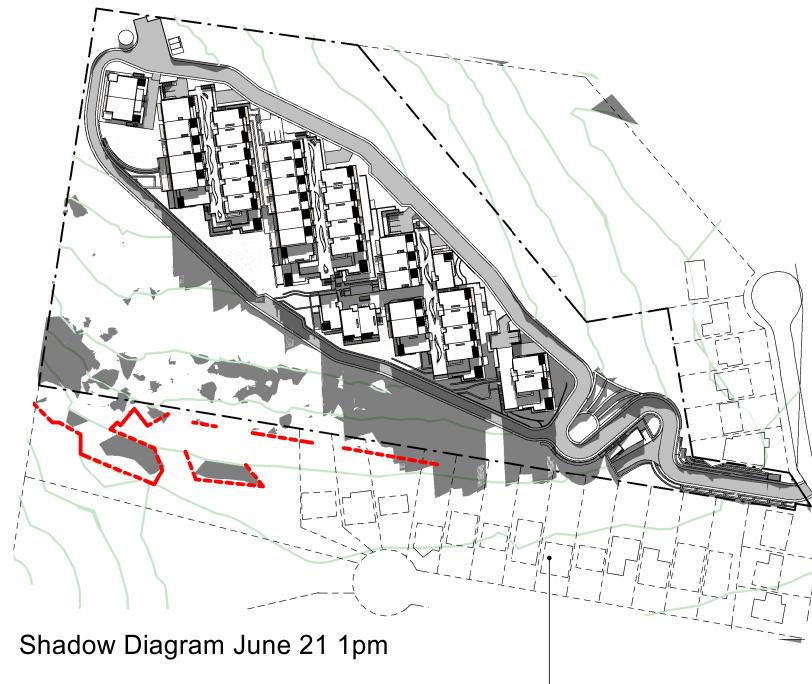





Shadow Diagram June 21 12pm

LOCATION OF EXISTING DWELLINGSs ON ADJACENT PROPERTIES SHOWN DOTTED

Shadow Diagram June 21 2pm

Shadow Diagram June 21 3pm


LEGEND LINE OF SHADOW CAST BY EXISTING TOPOGRPHY PRIOR TO PROPOSED NEW WORKS

DRAWING TITLE:

- SHADOW CASTING DOES NOT INCLUDE SHADOWS CAST BY THE EXISTING VEGETATION OR EXISTING STRUCTURES ON ADJACENT PROPERTIES

		REV.	DESCRIPTION	DATE
		1	Development Application	16.12.20
VERIFY ALL DIMENSIONS ON SITE BEFORE CONSTRUCTION COMMENCES.				
USE FIGURED DIMENSIONS IN PREFERENCE TO SCALE.	M			
VERIFIED ON SITE BEFORE CONSTRUCTION COMMENCES.	∣ш́∣			
LEVELS SHOWN ON PLAN ARE APPROXIMATE ONLY AND SHALL BE				
JONES GBB AND SHALL NOT BE USED OTHER THAN FOR THE PROJECT INTENDED WITHOUT WRITTEN AUTHORITY.	S			
THIS DRAWING ALWAYS REMAINS THE COPYRIGHT OF EDMISTON				
	NO			
trading as EDMISTON JONES GBB © 2019				
451)				
COPYRIGHT OF TILMENT PTY LTD (ACN 003 163				



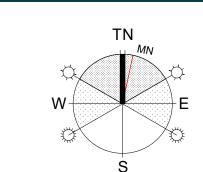



or Surewin Parkview Pty Ltd

PROJECT: Proposed Residential Development THE COSGROVE
At Lot 90 in D.P. 1086429, 14 Cosgrove Avenue

THE CO	SGROVE		
	00 in D.P. 108 le, NSW, 250	=	osgrove Avenu
_	WOLLONGONG T 02 4226 3600	NOWRA T 02 4421 6822	BATEMANS BAY T 02 4472 7388


	Site Shadow	Diagı	rams	Sheet 2	of 2	
venue,	SCALE: @ B1	DRAWN:		CHECKED: DATE		:
vonao,	1:1750	EJ		MFJ	16.12.2019	
ΑΥ	PROJECT No:		DWG	No:		ISSUE:
17-0049			D	4/27		1

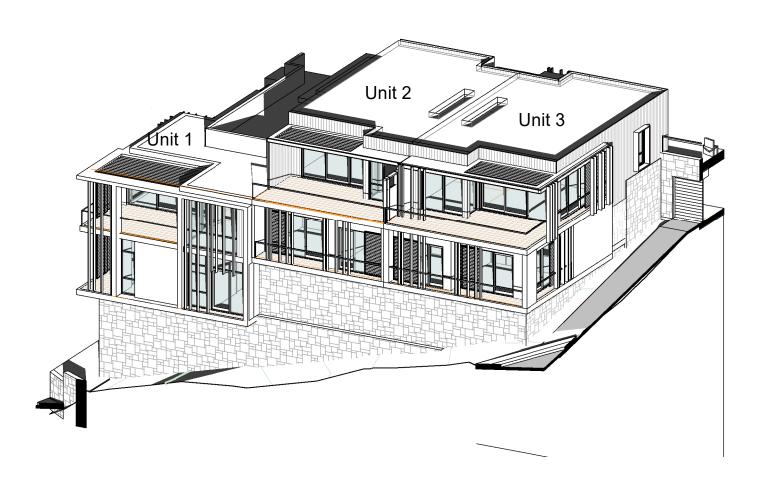

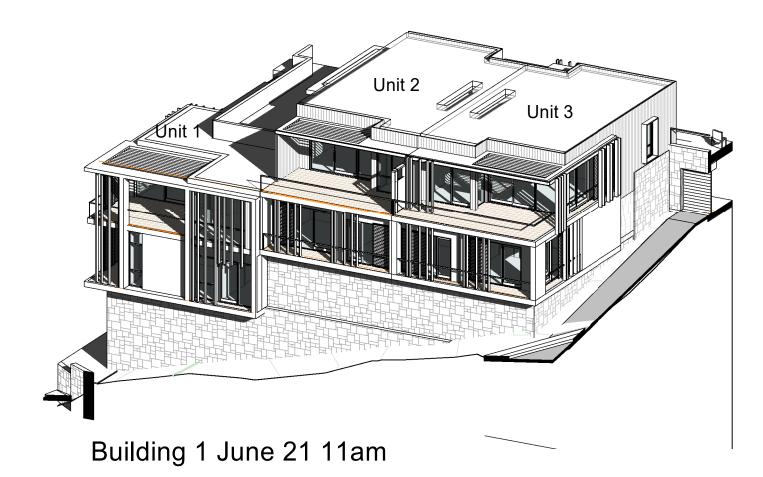


EXTENT OF DIRECT SUNLIGHT SOLAR PENETRATION INTO OPEN PLAN LIVING AREA (SHOWN BLUE HATCH)

Building 1 June 21 9am

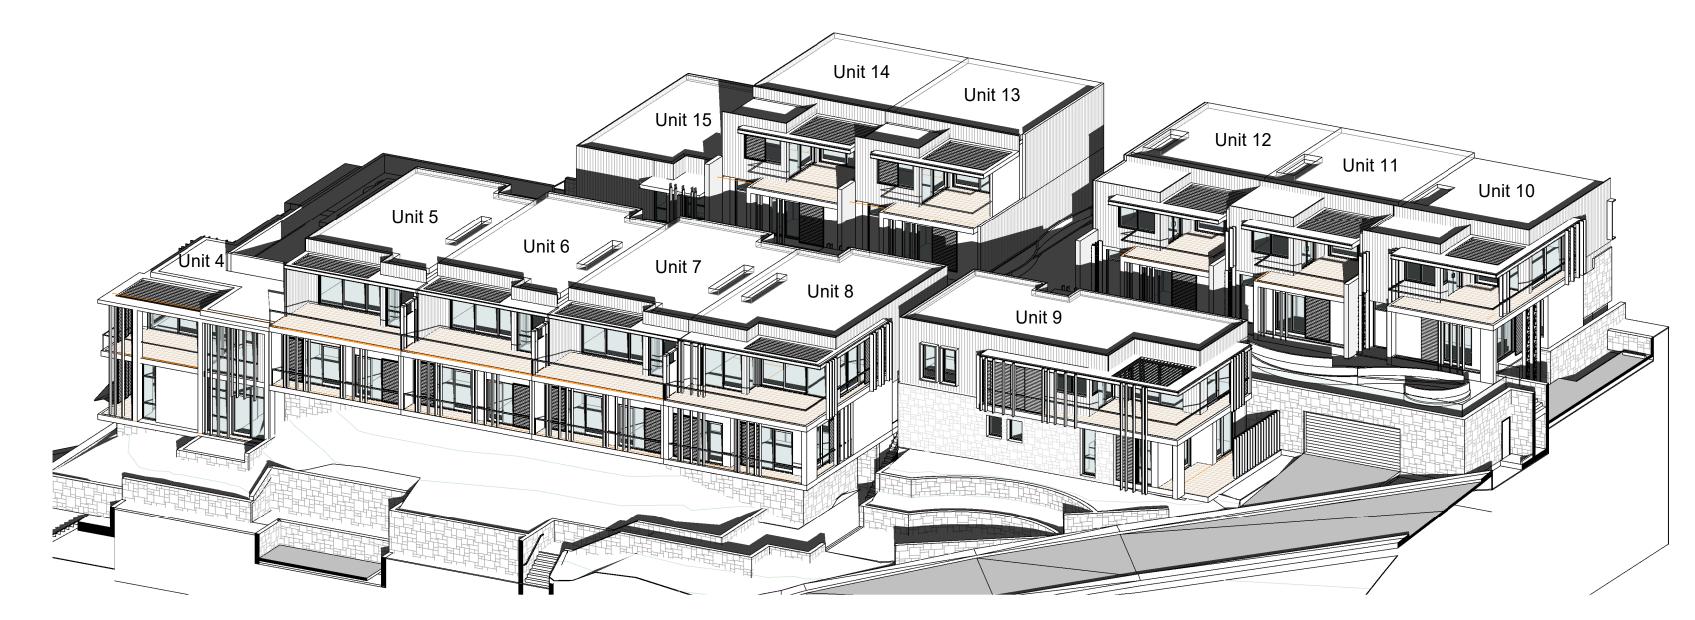


Building 2 June 21 9am

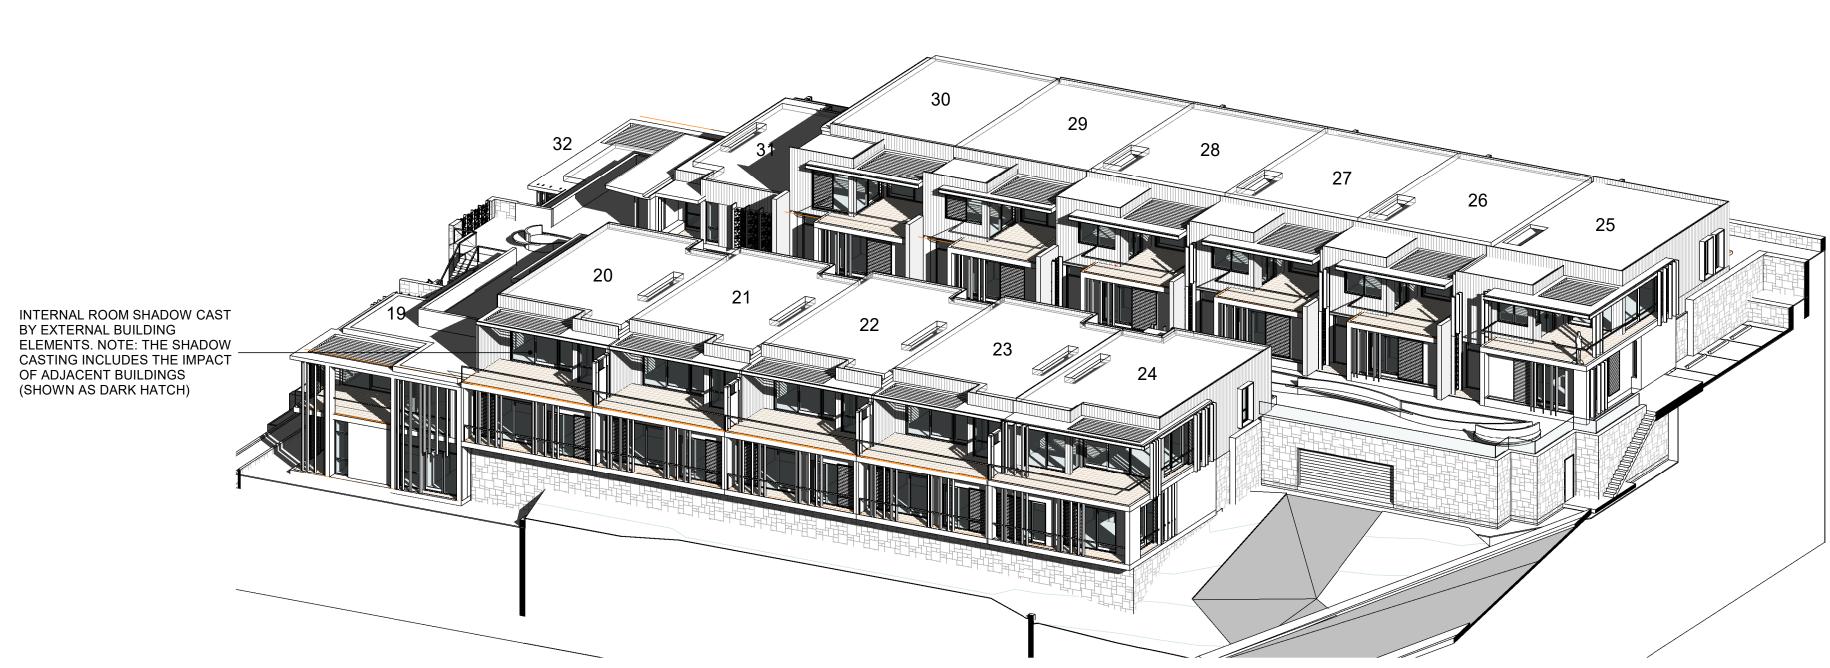

Building 3 June 21 11am

Building 3 June 21 9am

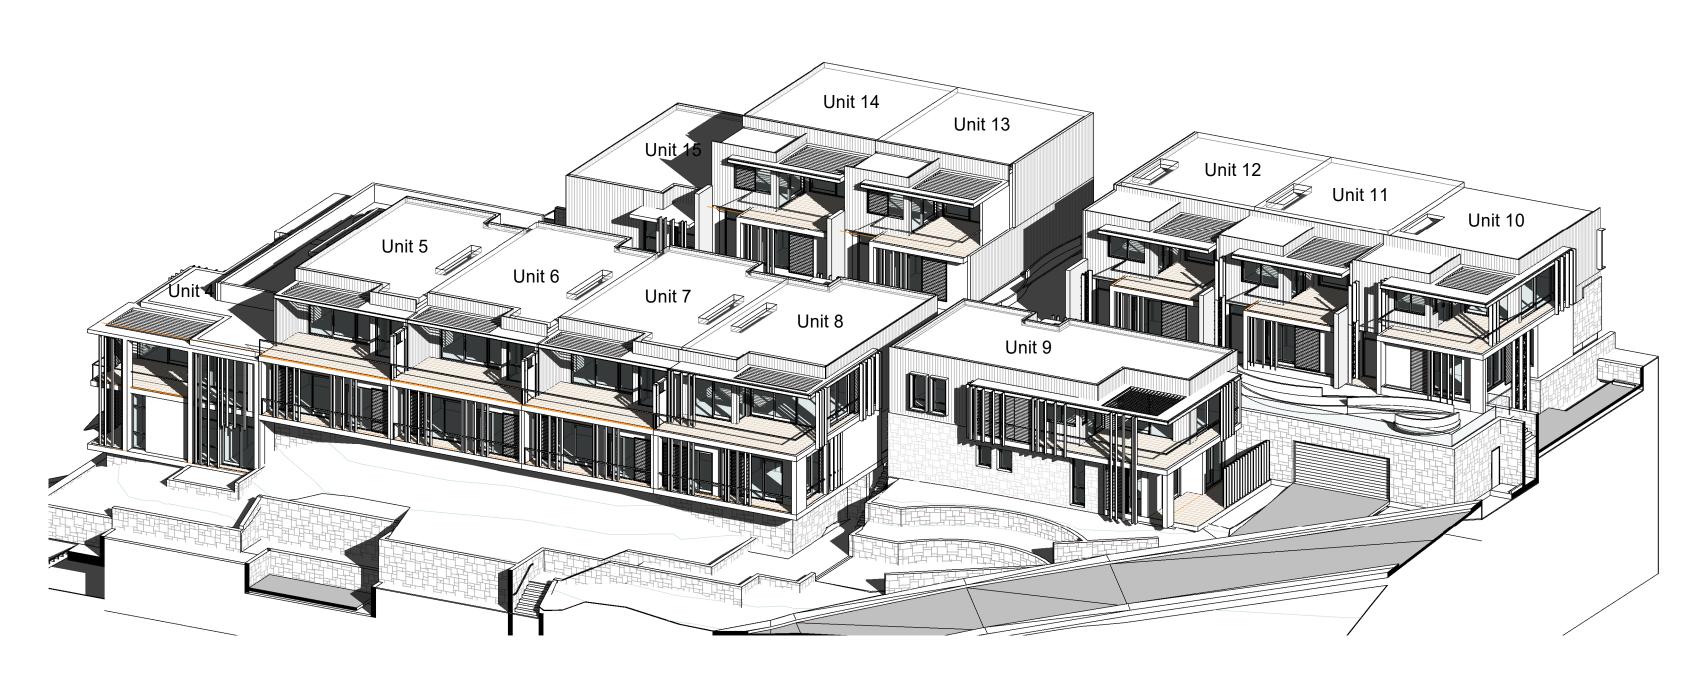

Building 2 June 21 11am

	Unit 16	Type 1	NO	
	Unit 17	Type 3	NO	
	Unit 18	Type 12	NO	
	Unit 19	Type 7	YES	`
	Unit 20	Type 1	YES	`
	Unit 21	Type 1	YES	`
	Unit 22	Type 1	YES	`
SOLAR ACCESS SUMMARY	Unit 23	Type 1	YES	`
	Unit 24	Type 2	YES	`
OPEN PLAN LIVING AREAS (L,D,K) RECIEVING DIRECT	Unit 25	Type 5	YES	`
SOLAR ACCESS ON JUNE 21 BETWEEN 9AM TO 3PM - 47% (22 DWELLINGS) RECEIVE 3 HOURS	Unit 26	Type 4	YES	`
- 34% (16 DWELLINGS) RECEIVE 2 HOURS	Unit 27	Type 4	YES	`
·	Unit 28	Type 4	YES	`
TERRACES (PRIVATE OPEN SPACE) RECIEVING DIRECT	Unit 29	Type 6	YES	`
SOLAR ACCESS ON JUNE 21 BETWEEN 9AM TO 3PM - 74% OF TERRACES RECEIVE 3 HOURS to 50% OF THE	Unit 30	Type 6	YES	`
REQUIRED AREA	Unit 31	Type 1	NO	
TEGOTTES TITES	Unit 32	Type 8	NO	
AT LEAST 50% OF THE REQUIRED COMMUNAL OPEN	Unit 33	Type 7	NO	`
SPACE AREA RECEIVES AT LEAST 3 HOURS OF DIRECT	Unit 34	Type 1	YES	`
SUNLIGHT BETWEEN 9.00AM AND 3.00PM ON JUNE 21.	Unit 35	Type 1	YES	`
	Unit 36	Type 1	YES	`
	Unit 37	Type 1	YES	`
LEGEND	Linit 20 Time 4 VEC		`	
LLGLIND	Unit 39	Type 2	YES	`
EXTENT OF DIRECT SUNLIGHT	Unit 40	Type 9	YES	`
SOLAR PENETRATION INTO	Unit 41	Type 4	YES	
OPEN PLAN LIVING AREA	Unit 42	Type 4	YES	
	Unit 43	Type 6	YES	

SUNLIG	HT BETWEEN 9.00AM AND 3.00PM ON JUNE 21.
	LEGEND
	EXTENT OF DIRECT SUNLIGHT SOLAR PENETRATION INTO OPEN PLAN LIVING AREA
	INTERNAL ROOM SHADOW CAST BY EXTERNAL BUILDING ELEMENTS. NOTE: THE SHADOW CASTING INCLUDES THE IMPACT OF ADJACENT BUILDINGS

	COPYRIGHT OF TILMENT PTY LTD (ACN 003 163 451) trading as EDMISTON JONES GBB © 2019	_			
6/12/2019 11:29:37 AM	THIS DRAWING ALWAYS REMAINS THE COPYRIGHT OF EDMISTON JONES GBB AND SHALL NOT BE USED OTHER THAN FOR THE PROJECT INTENDED WITHOUT WRITTEN AUTHORITY. LEVELS SHOWN ON PLAN ARE APPROXIMATE ONLY AND SHALL BE VERIFIED ON SITE BEFORE CONSTRUCTION COMMENCES. USE FIGURED DIMENSIONS IN PREFERENCE TO SCALE. VERIFY ALL DIMENSIONS ON SITE BEFORE CONSTRUCTION COMMENCES.	REVISION			
6/1			1	Development Application	16.12.2019
-			REV.	DESCRIPTION	DATE

SOLAR ACCESS - OPEN PLAN LIVING & POS

DRAWING TITLE: For Surewin Parkview Pty Ltd | Proposed Residential Development Dwelling Solar Access Sheet 1 of 2 THĖ COSGROVE At Lot 90 in D.P. 1086429, 14 Cosgrove Avenue, 1:200 Keiraville, NSW, 2500

Unit 45 Type 2
Unit 46 Type 11


T 02 4226 3600 T 02 4421 6822 T 02 4472 7388


MFJ 16.12.2019 DA/28 17-0049

DIRECT SUNLIGHT SOLAR ACCESS SCHEDULE (JUNE 21)


NO YES YES NO


YES
YES
YES
YES
YES
YES
YES
NO
YES
NO

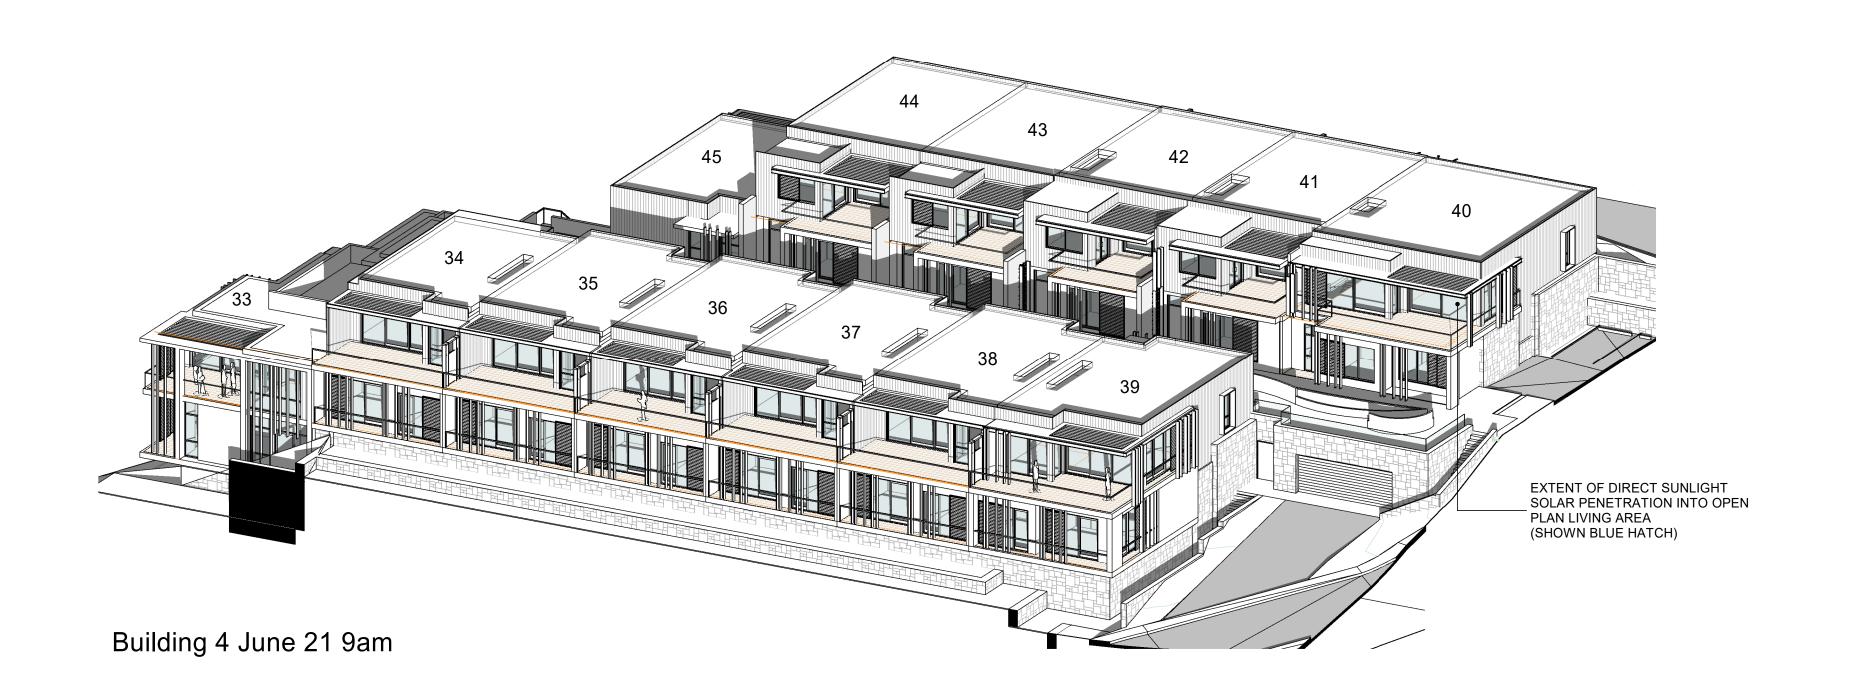

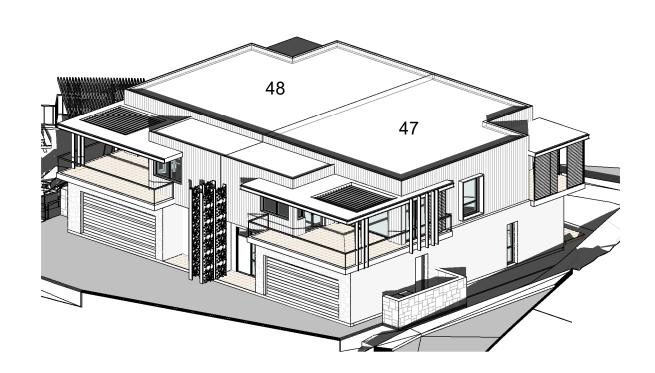

Building 5 June 21 9am

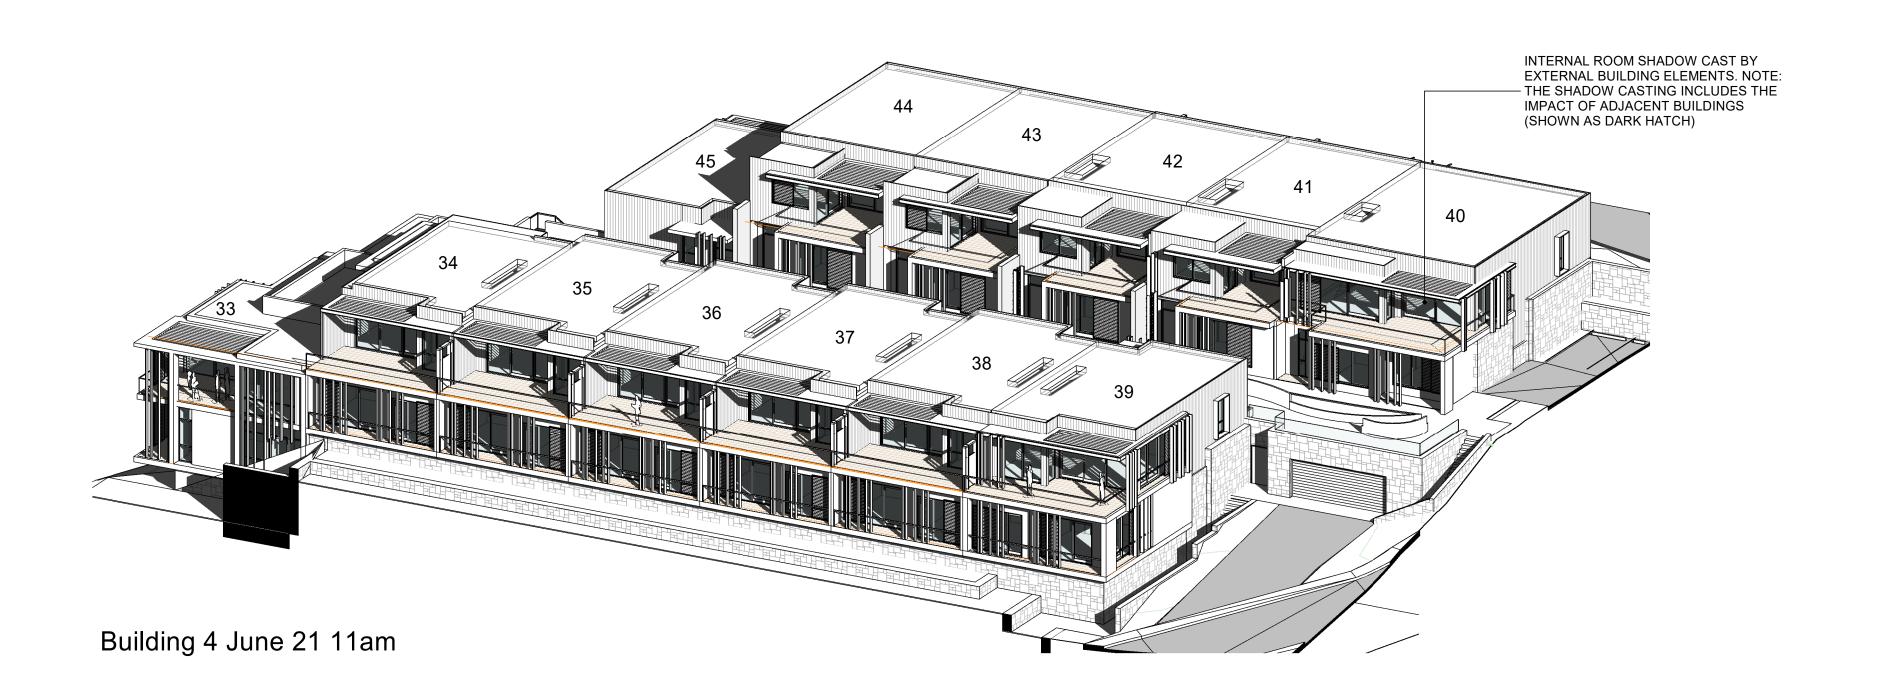

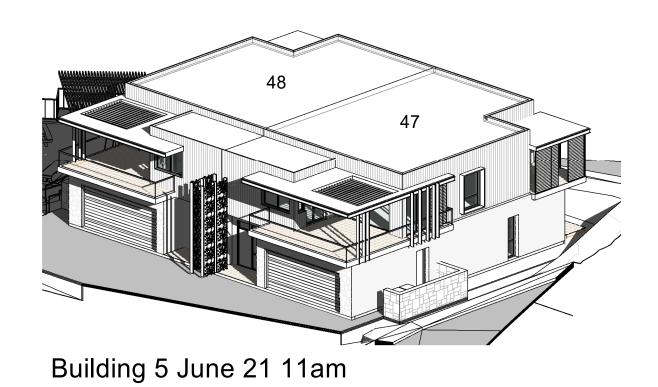

SOLAR ACCESS SUMMARY

OPEN PLAN LIVING AREAS (L,D,K) RECIEVING DIRECT SOLAR ACCESS ON JUNE 21 BETWEEN 9AM TO 3PM - 47% (22 DWELLINGS) RECEIVE 3 HOURS - 34% (16 DWELLINGS) RECEIVE 2 HOURS

TERRACES (PRIVATE OPEN SPACE) RECIEVING DIRECT SOLAR ACCESS ON JUNE 21 BETWEEN 9AM TO 3PM
- 74% OF TERRACES RECEIVE 3 HOURS to 50% OF THE REQUIRED AREA

AT LEAST 50% OF THE REQUIRED COMMUNAL OPEN SPACE AREA RECEIVES AT LEAST 3 HOURS OF DIRECT SUNLIGHT BETWEEN 9.00AM AND 3.00PM ON JUNE 21.

LEGEND

EXTENT OF DIRECT SUNLIGHT SOLAR PENETRATION INTO OPEN PLAN LIVING AREA

INTERNAL ROOM SHADOW CAST BY EXTERNAL BUILDING ELEMENTS. NOTE: THE SHADOW CASTING INCLUDES THE IMPACT OF ADJACENT BUILDINGS

Dwelling No	Dwelling Type	Open Plan Living Solar Access 9am	Open Plan Living Solar Access 11am	Open Plan Living Solar Access 12pm	(POS) Terrace 3hrs
Unit 1	Type 7	YES	YES	NO	NO
Unit 2	Type 1	YES	YES	NO	YES
Jnit 3	Type 2	YES	YES	YES	YES
Jnit 4	Type 7	YES	YES	NO	NO
Jnit 5	Type 1	YES	YES	NO	YES
Jnit 6	Type 1	YES	YES	NO	YES
Jnit 7	Type 1	YES	YES	NO	YES
Jnit 8	Type 2	YES	YES	YES	YES
Jnit 9	Type 12	YES	YES	YES	YES
Jnit 10	Type 5	YES	YES	YES	YES
Jnit 11	Type 4	YES	YES	YES	YES
Jnit 12	Type 4	YES	YES	YES	YES
Jnit 13	Type 6	YES	YES	YES	YES
Jnit 14	Type 6	YES	YES	YES	YES
Jnit 15	Type 2	NO	NO	NO	NO
Jnit 16	Type 1	NO	NO	NO	NO
Jnit 17	Type 3	NO	NO	NO	NO
Jnit 18	Type 12	NO	NO	NO	NO
Jnit 19	Type 7	YES	YES	NO	NO
Jnit 20	Type 1	YES	YES	NO	YES
Jnit 21	Type 1	YES	YES	NO	YES
Jnit 22	Type 1	YES	YES	NO	YES
Jnit 23	Type 1	YES	YES	NO	YES
Jnit 24	Type 2	YES	YES	YES	YES
Jnit 25	Type 5	YES	YES	YES	YES
Jnit 26	Type 4	YES	YES	YES	YES
Jnit 27	Type 4	YES	YES	YES	YES
Jnit 28	Type 4	YES	YES	YES	YES
Jnit 29	Type 6	YES	YES	YES	YES
Jnit 30	Type 6	YES	YES	YES	YES
Jnit 31	Type 1	NO	NO	NO	NO
Jnit 32	Type 8	NO	NO	NO	NO
Jnit 33	Type 7	NO	YES	NO	NO
Jnit 34	Type 1	YES	YES	NO	YES
Jnit 35	Type 1	YES	YES	NO	YES
Jnit 36	Type 1	YES	YES	NO	YES
Jnit 37	Type 1	YES	YES	NO	YES
Jnit 38	Type 1	YES	YES	NO	YES
Jnit 39	Type 2	YES	YES	YES	YES
Jnit 40	Type 9	YES	YES	YES	YES
Init 41	Type 4	YES	YES	YES	YES
Jnit 42	Type 4	YES	YES	YES	YES
Init 42	Type 4	YES	YES	YES	YES
Jnit 43	Type 6	YES	YES	YES	YES
Jnit 45	Type 0	NO	NO NO	NO NO	NO NO
Jnit 45	Type 11	NO	NO	NO	YES
Jnit 47	Type 10	YES	YES	YES	NO

DRAWING TITLE:

			Botolopinont, upplication	10.12.20
		1	Development Application	16.12.20
COMMENCES.				
VERIFY ALL DIMENSIONS ON SITE BEFORE CONSTRUCTION				
USE FIGURED DIMENSIONS IN PREFERENCE TO SCALE.				
VERIFIED ON SITE BEFORE CONSTRUCTION COMMENCES.	Ш			
LEVELS SHOWN ON PLAN ARE APPROXIMATE ONLY AND SHALL BE	≅			
JONES GBB AND SHALL NOT BE USED OTHER THAN FOR THE PROJECT INTENDED WITHOUT WRITTEN AUTHORITY.	\overline{S}			
THIS DRAWING ALWAYS REMAINS THE COPYRIGHT OF EDMISTON	0			
	Z			
trading as EDMIOTON SONEO OBD © 2015				
451) trading as EDMISTON JONES GBB © 2019				
COPYRIGHT OF TILMENT PTY LTD (ACN 003 163				

SOLAR ACCESS - OPEN PLAN LIVING & POS

CLIENT	
For Surewin Parkview Pty Ltd	
,	


t	Proposed Residential Development THE COSGROVE							
	At Lot 90 in D.P. 1086429, 14 Cosgrove Avenu							

: 90 in D.P. 108 ville, NSW, 250	· ·	osgrove Aveni	_
WOLLONGONG	NOWRA	BATEMANS BAY	
T 02 4226 3600	T 02 4421 6822	T 02 4472 7388	

Dwelling Solar Access Sheet 2 of 2							
SCALE: @ B1	SCALE: @ B1 DRAW			DATE:			
1 : 200	EJ		MFJ	16.12.2019			
PROJECT No:		DWG	No:		ISSUE:		
17-0049		D	4/29		1		




Building 4 - EAST (Typical Elevation)

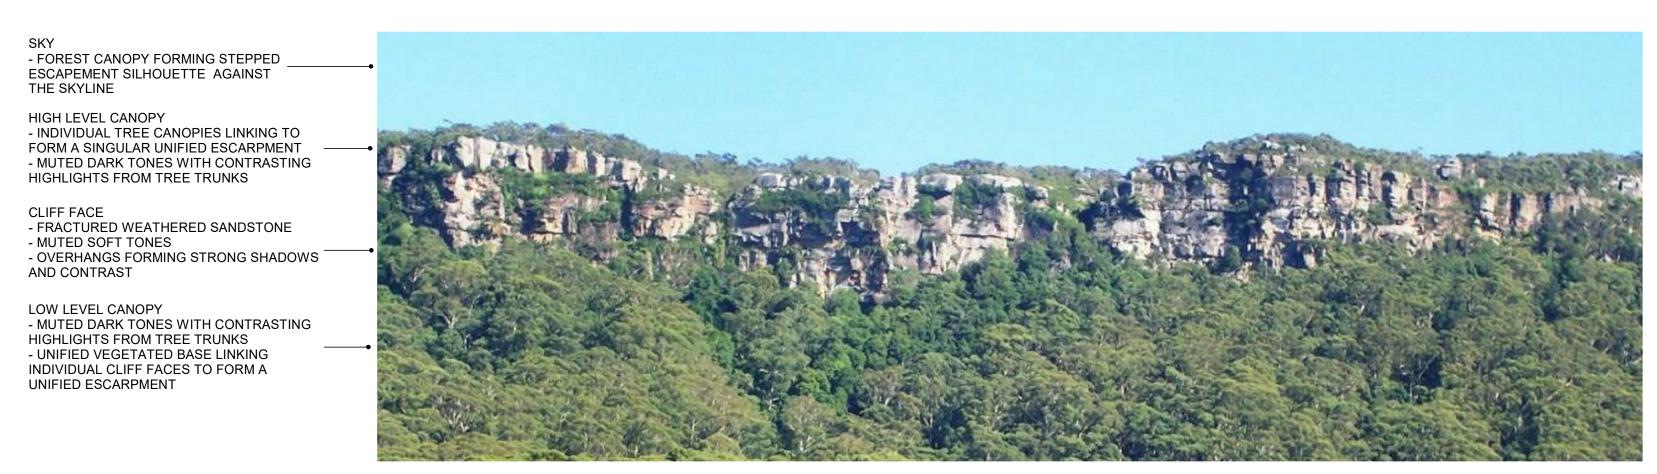


Illawarra Escarpment - Material and Tonal Layering



Building 4 - NORTH (Typical Elevation)

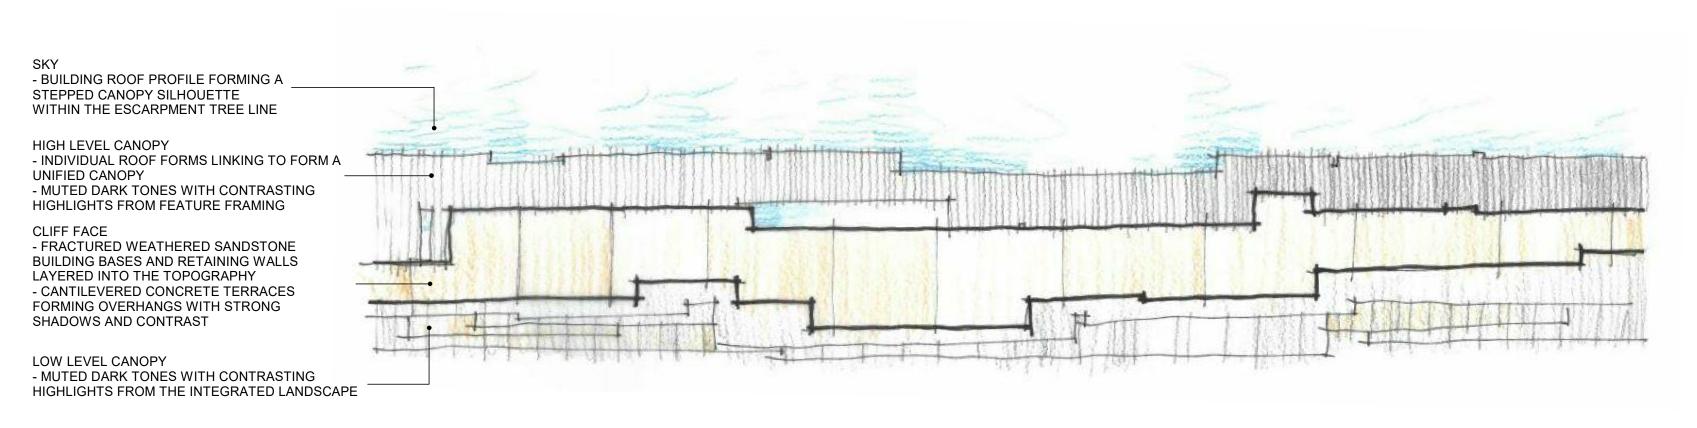

Concept Elevation Diagramme - Material and Tonal Layering

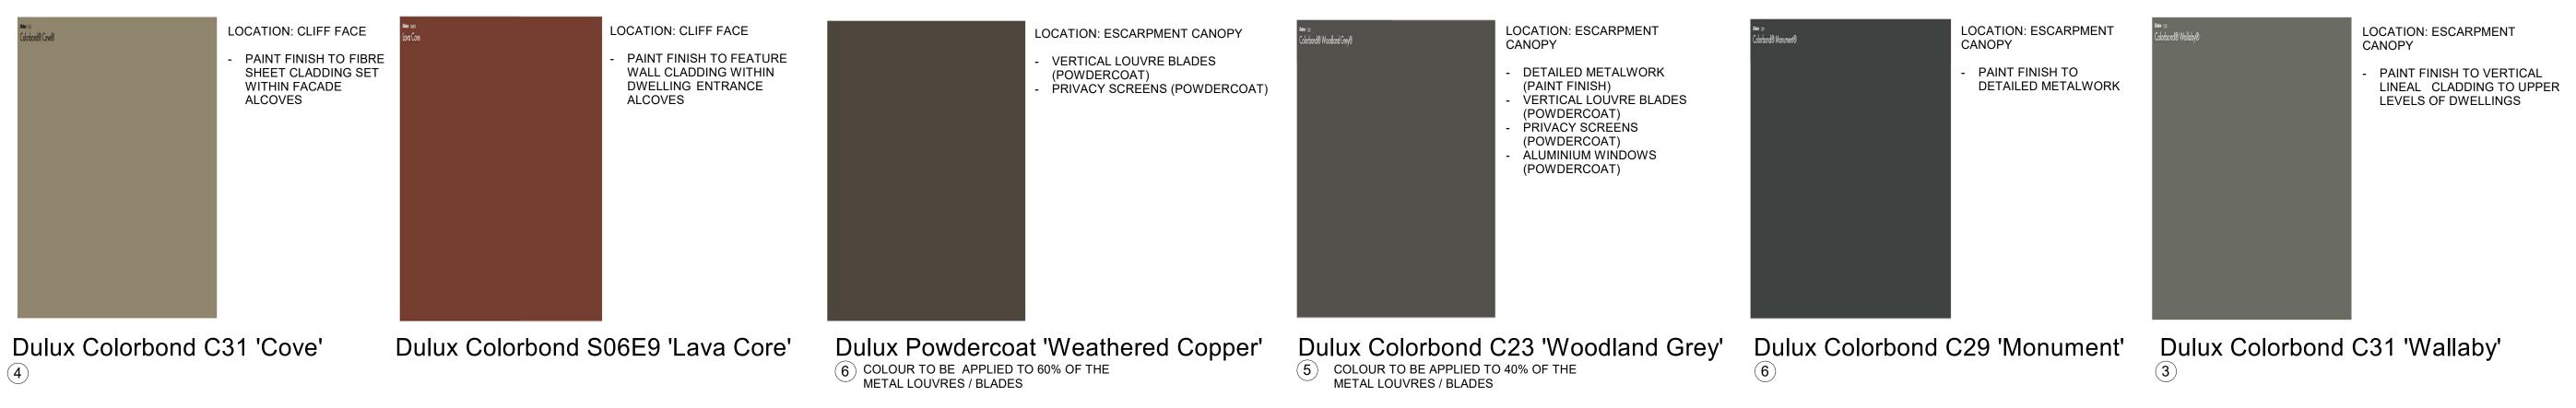

Colours

Materials

Lineal Cladding



Expressed Concrete




Sandstone

	LEGEND - MATERIALS	S & R	OOM TYPES
MAT	ERIAL TYPE	ROOM	TYPE
② EXF ③ LIN JOI ④ SHE (PA ⑤ ALU SCF (PO ⑦ FAC ⑧ CON ⑨ COI ROI	PRESSED INSITU CONCRETE FRAME EAL CLADDING SYSTEM, EXPRESSED NTS (PAINTED FIBRE CEMENT) EET CLADDING SYSTEM, SET JOINTS INTED FIBRE CEMENT) JMINUM FRAMED WINDOWS WDER COATED FINISH) MINIUM FRAMED PRIVACY SLIDING REENS AND FIXED BLADES WDERCOAT FINISH) EE BLOCKWORK NCRETE FRAME FLOOR STRUCTURE TH LIGHT WEIGHT STUD INFILL FRAMES NCRETE ROOF STRUCTURE (GREEN OF OVER) STERBOARD WALL & CEILING LINING	B BTH D ENS ENT G K L LDY T WIR POS	BEDROOM BATH DINING ENSUITE ENTRY GARAGE KITCHEN LIVING LAUNDRY TERRACE (POS) WALK IN ROBE PRIVATE OPEN SPACE YARD

		REV.	DESCRIPTION	DATE
		1	Development Application	16.12.201
VERIFY ALL DIMENSIONS ON SITE BEFORE CONSTRUCTION COMMENCES.				
USE FIGURED DIMENSIONS IN PREFERENCE TO SCALE.				
LEVELS SHOWN ON PLAN ARE APPROXIMATE ONLY AND SHALL BE VERIFIED ON SITE BEFORE CONSTRUCTION COMMENCES.				
PROJECT INTENDED WITHOUT WRITTEN AUTHORITY.	<u>S</u>			
THIS DRAWING ALWAYS REMAINS THE COPYRIGHT OF EDMISTON JONES GBB AND SHALL NOT BE USED OTHER THAN FOR THE	0			
	Z			
trading as EDMISTON JONES GBB © 2019				
COPYRIGHT OF TILMENT PTY LTD (ACN 003 163 451)				

EXTERNAL PALETTE OF COLOURS & MATERIALS

For Surewin Parkview Pty Ltd		sed Residentia OSGROVE	l Developm	ent	DRAWING TITLE: External Materials & Colour Palette					
		At Lot 90 in D.P. 1086429, 14 Cosgrove Avenue, Keiraville, NSW, 2500			SCALE: @ B1 1:200	DRAW E		CHECKED:	16.1	12.2019
	=]	WOLLONGONG T 02 4226 3600 W www.aej.com.au	NOWRA T 02 4421 6822 E aej@aej.com.au	BATEMANS BAY T 02 4472 7388	PROJECT No: 17-0049		Dwo	A/30		ISSUE:

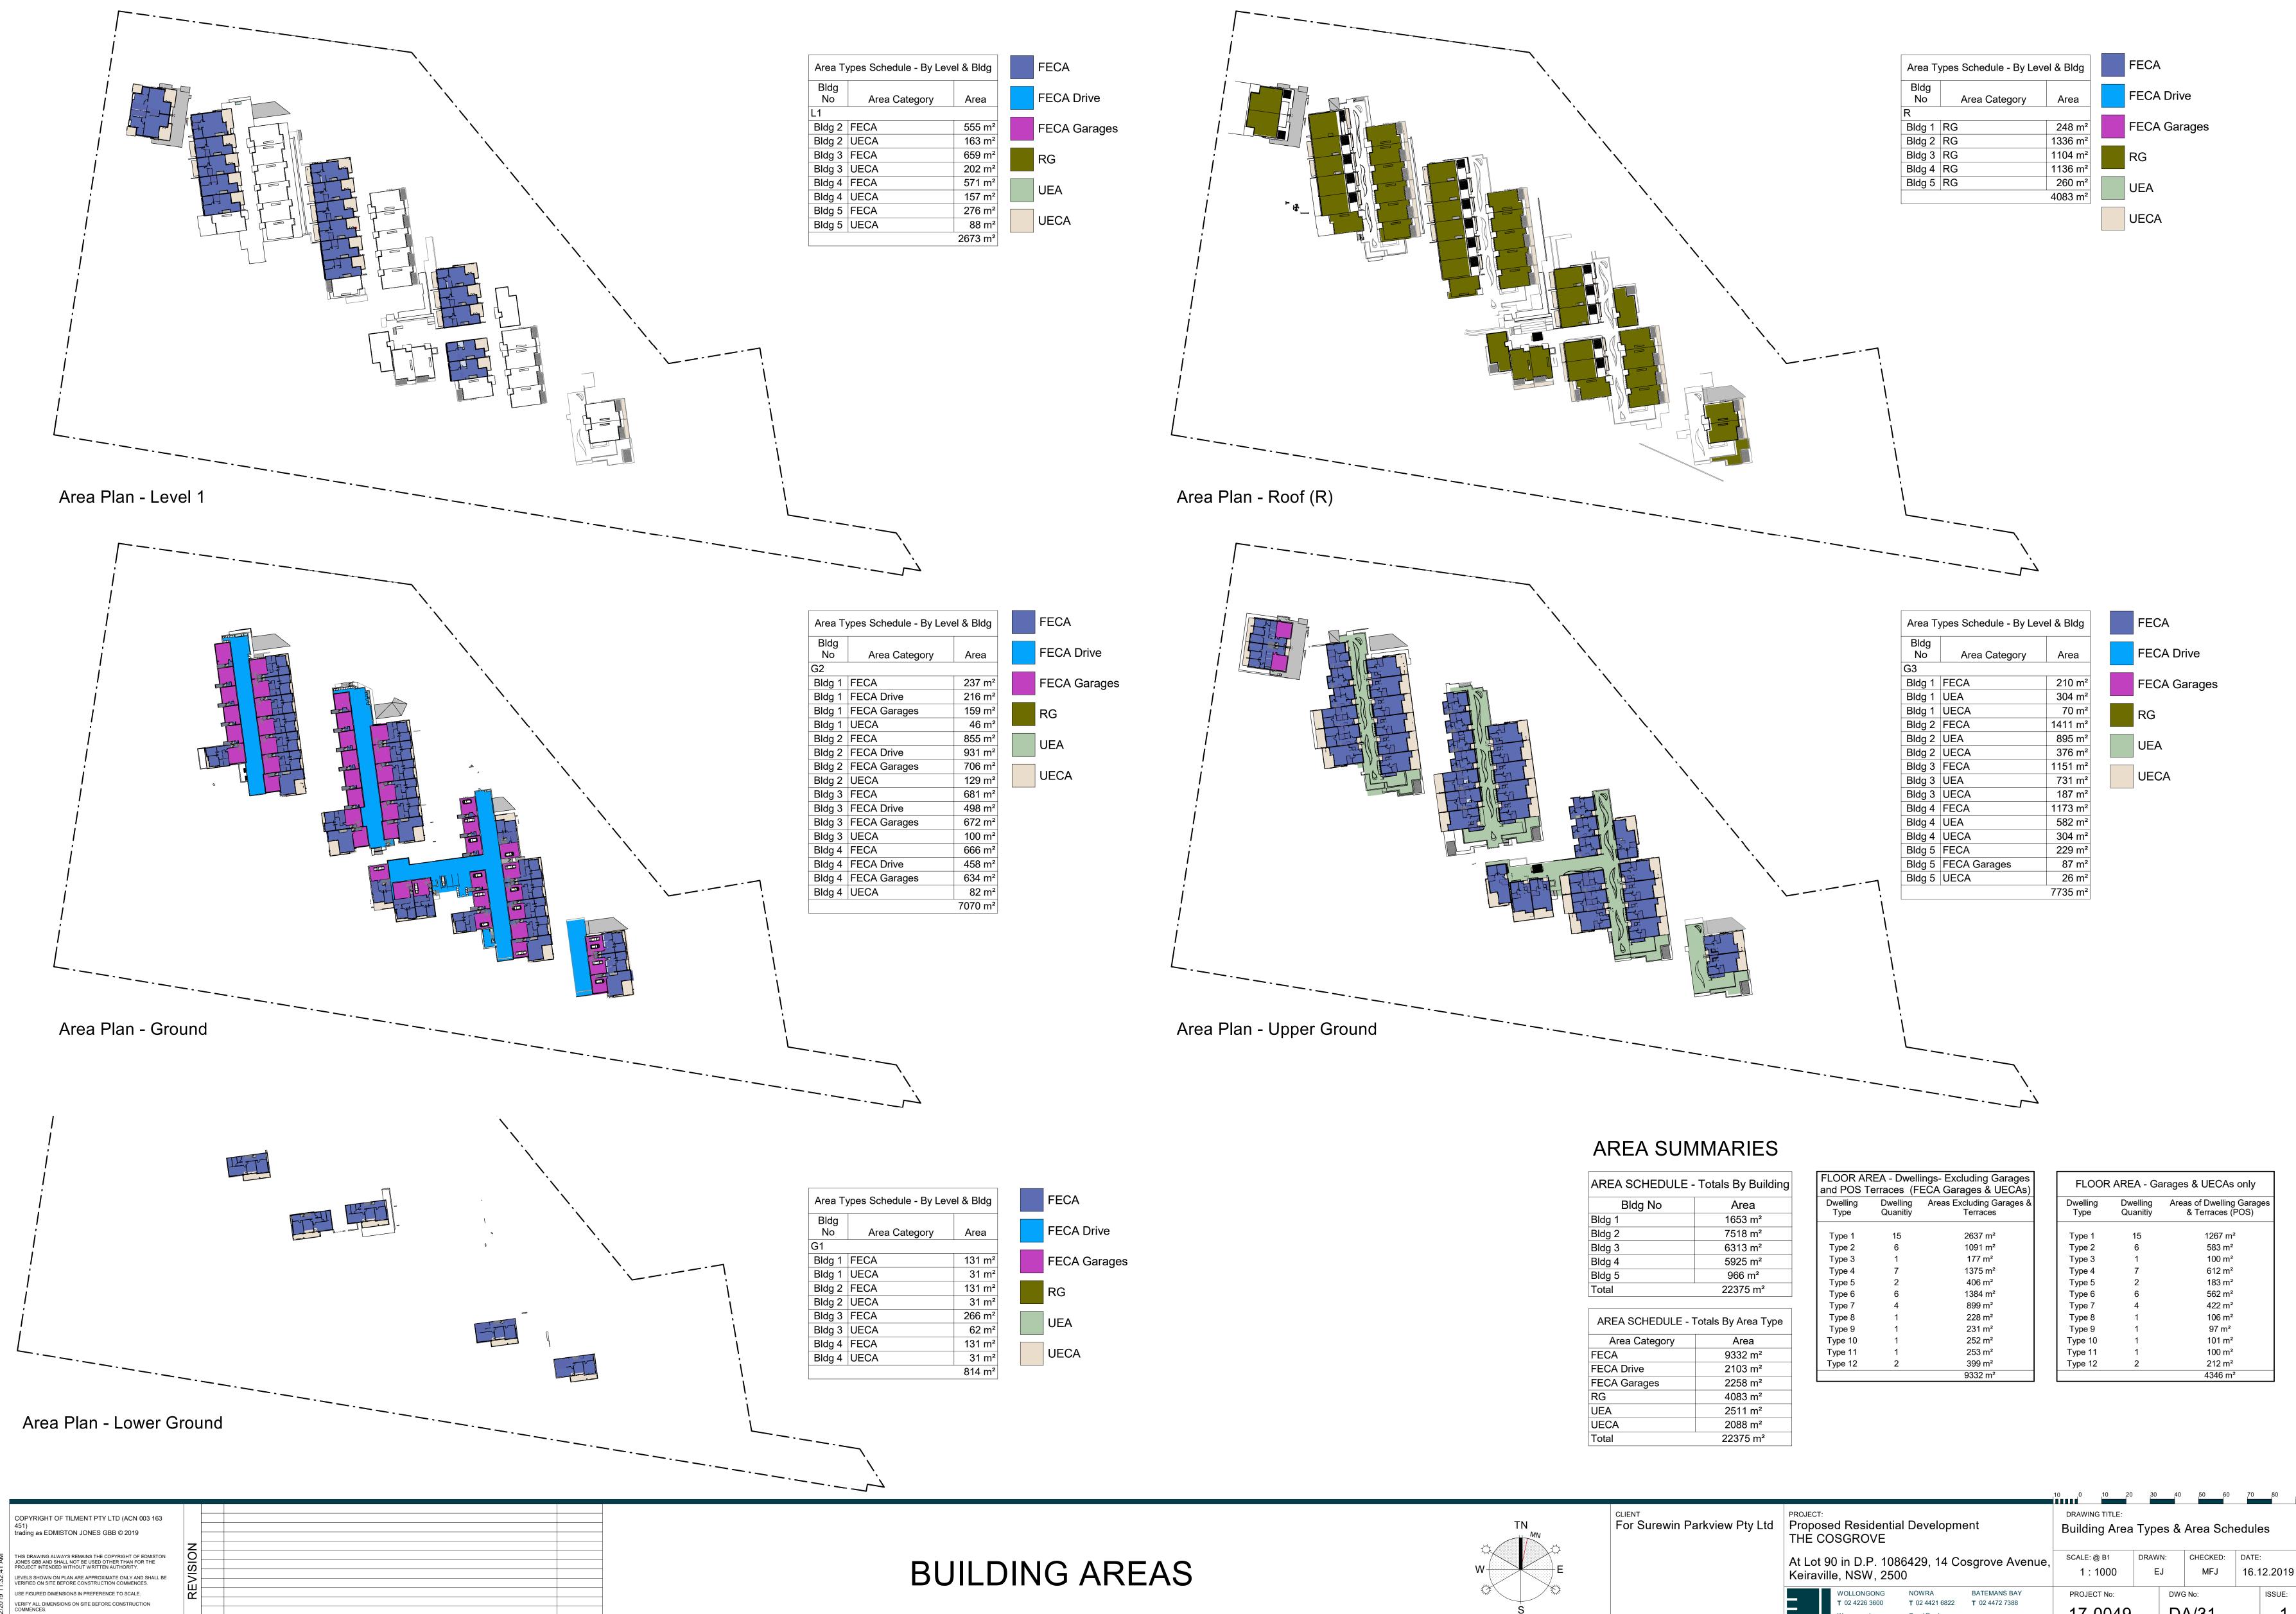


16.12.2019


DATE

1 Development Application


DESCRIPTION

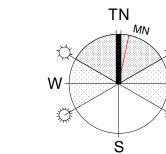

•	ed Residentia OSGROVE	Building Area Types &				
	90 in D.P. 108 lle, NSW, 250	SCALE: @ B1 1:1000	DRAW E			
	WOLLONGONG	NOWRA	BATEMANS BAY	PROJECT No:		DV
	T 02 4226 3600 W www.aej.com.au	T 02 4421 6822 E aej@aej.com.au	T 02 4472 7388	17-0049		

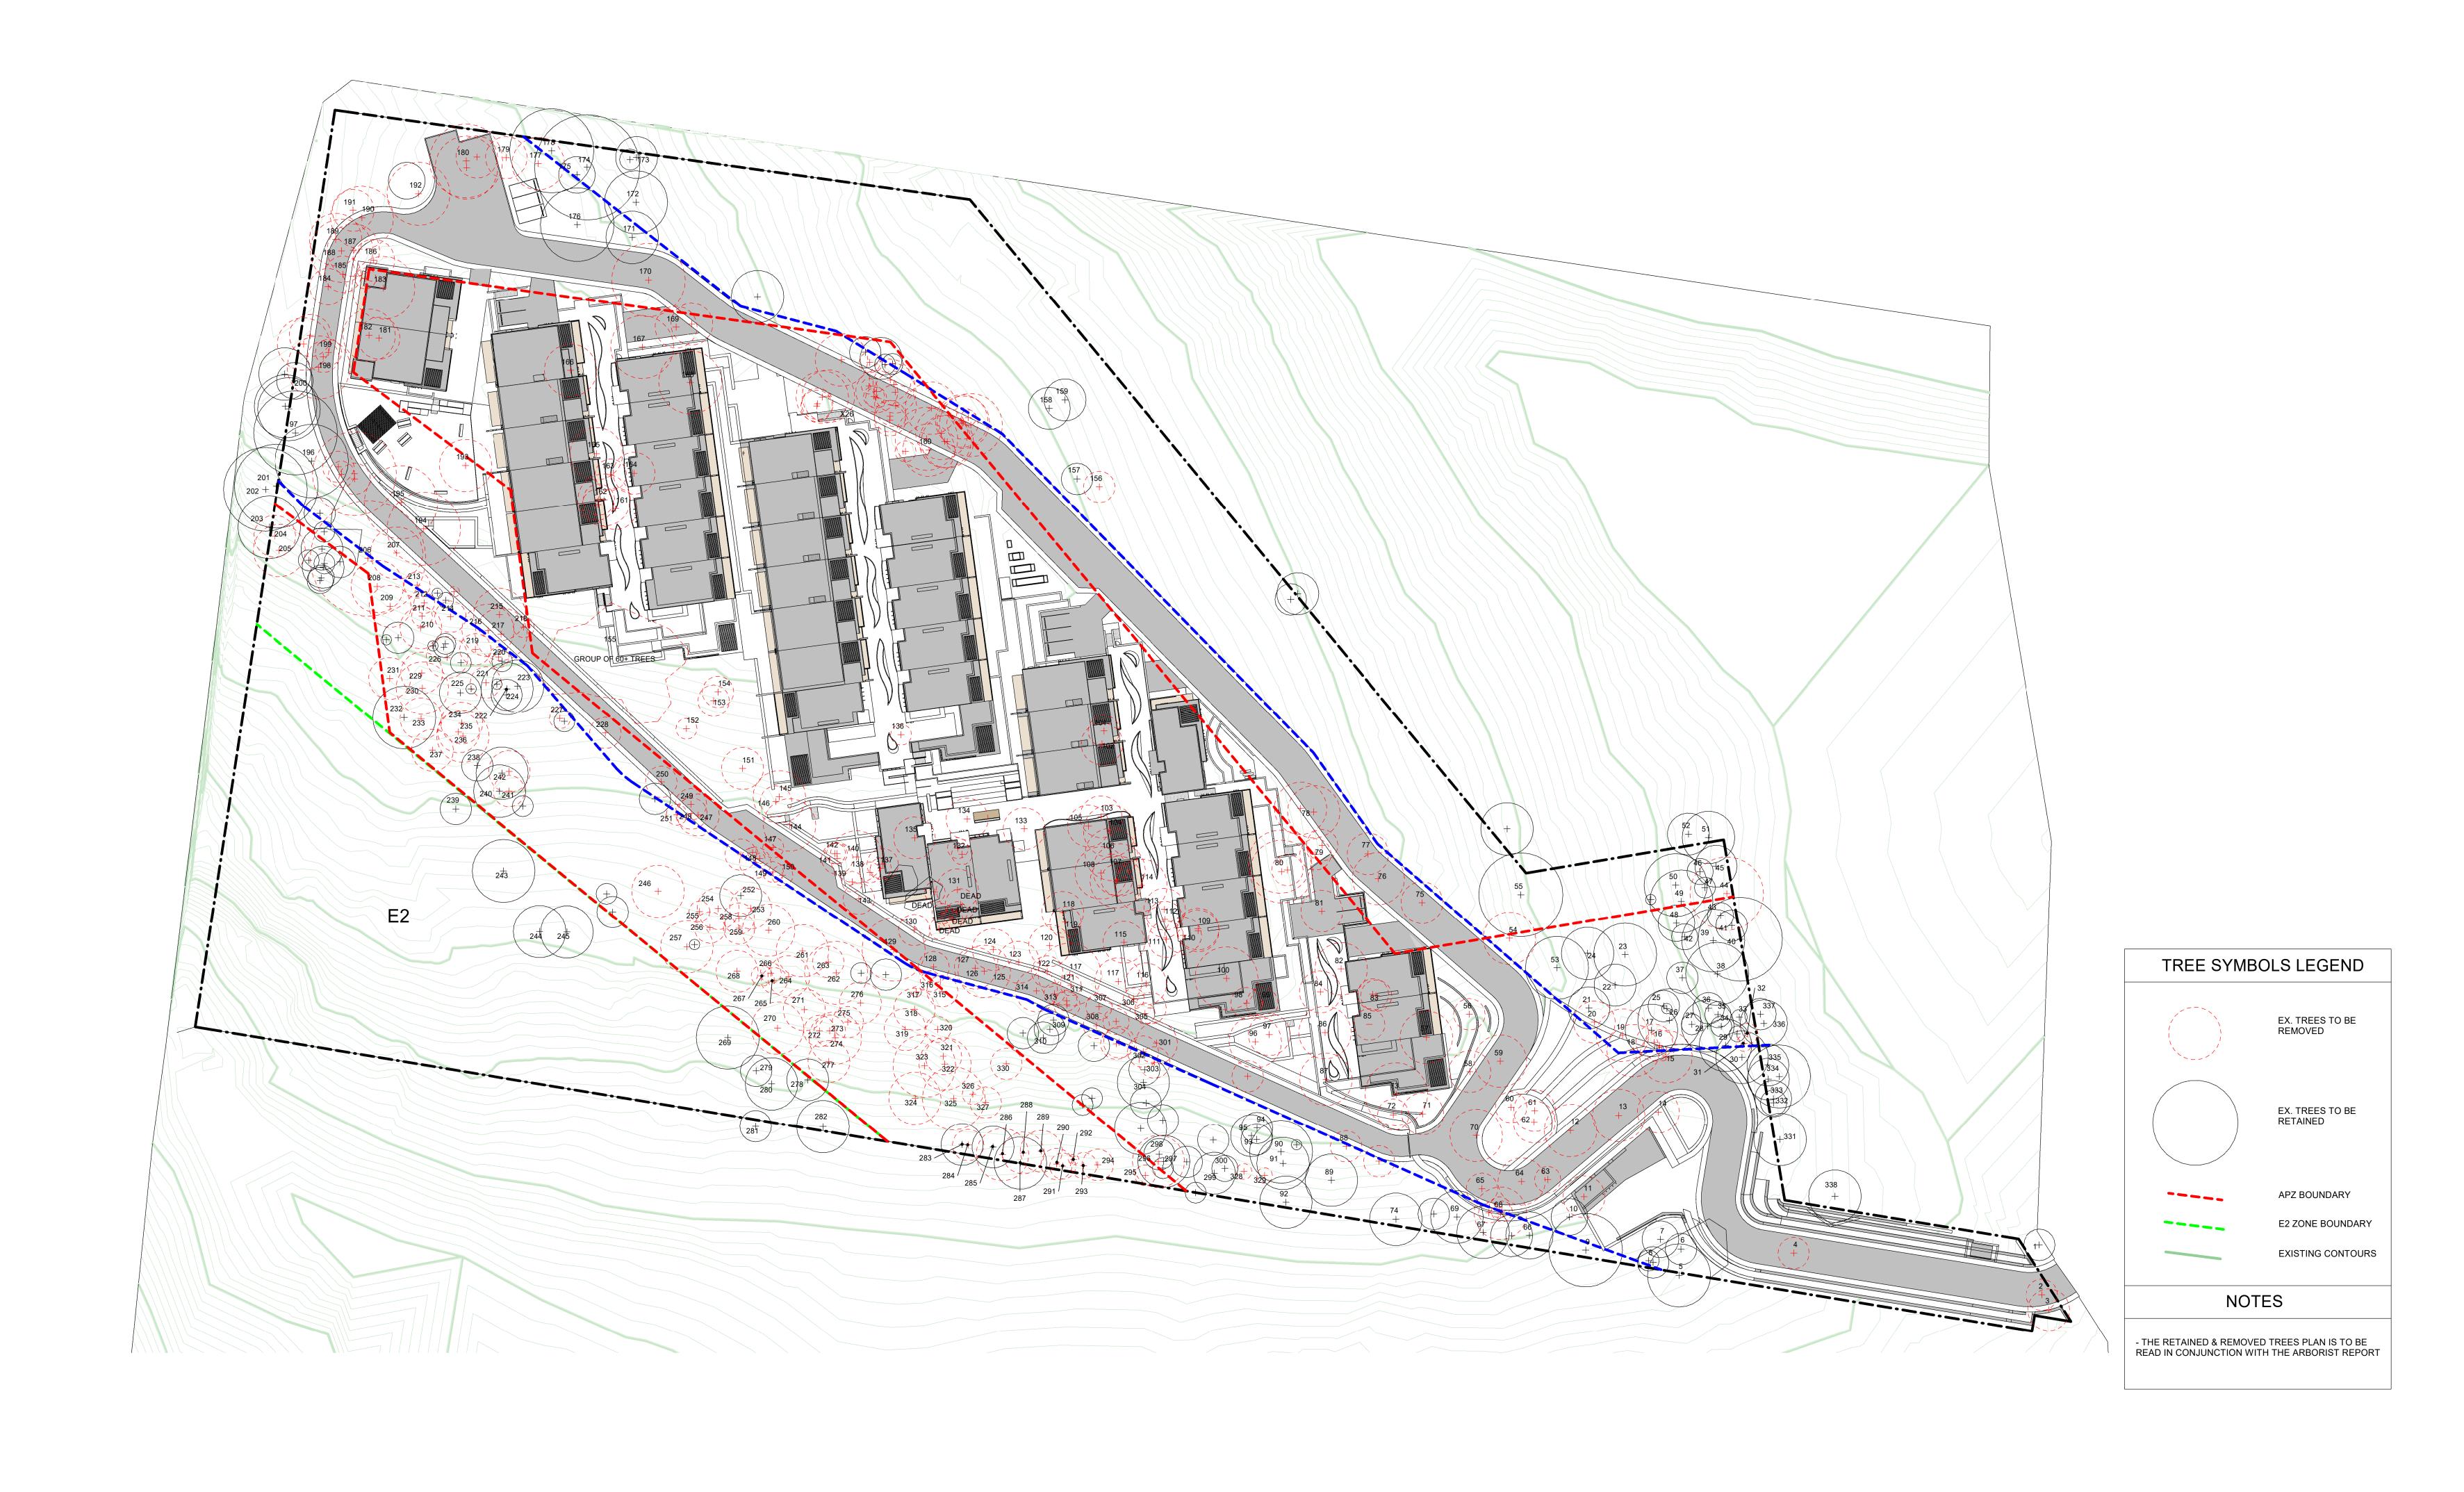



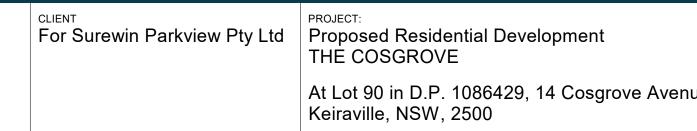

At Lot	: 9	0SGROVE 0 in D.P. 108 le, NSW, 250	•	sgrove Avenue,
_		WOLLONGONG T 02 4226 3600	NOWRA T 02 4421 6822	BATEMANS BAY T 02 4472 7388
		W www.aej.com.au	E aej@aej.com.au	

	DRAWING TITLE:							
	Retained & Removed Trees							
	COME. © D4	DDAM	'NI.	CHECKED.	DATE			
ue,	SCALE: @ B1	DRAWN:		CHECKED:	DATE:			
	As indicated	EJ		SS	16.12.2019			
	PROJECT No:		DWG	S No:		ISSUE:		
	17-0049		D	۹/49		1		



- ROSELLA BUILDING 3 COMMUNAL VEGETABLE

SCHEDULE OF LANDSCAPE REQUIREMENTS

DCP REQUIREMENTS SITE AREA 41,934 sqm SITE AREA (EXCL. E2 ZONE) 36,753 sqm REQUIRED LANDSCAPE (30% OF SITE AREA EXCL. E2 ZONE) 11,026 sqm

REQUIRED DEEP SOIL ZONE (DSZ) (15% OF SITE AREA EXCL. E2 ZONE) 5,513 sqm REQUIRED COMMUNAL OPEN SPACE (COS) (5M2 X 47 UNITS) 235 sqm

PROPOSED LANDSCAPE AREAS

LANDSCAPE (INCL. APZ) 21,209 sqm DEEP SOIL ZONE (INCL. APZ) 15,370 sqm COMMUNAL OPEN SPACE 2893 sqm

LANDSCAPE SYMBOLS LEGEND

10M DIAM. FEATURE

6M DIAM. TREES

2M DIAM SHRUBS

1M DIAM SHRUBS &

PERENNIALS < 1.2M

GROUNDCOVERS

< 0.3M HIGH

LAWN AREAS

GREEN ROOF

TRACKS

APZ MAINTENANCE

STORMWATER PIT

WATER TANKS

APZ BOUNDARY

E2 ZONE BOUNDARY

EXISTING CONTOURS

PAVING

CLIMBERS

< 3M HIGH

< 8M HIGH

TREES < 15M HIGH



 TO ENHANCE AND BUILD ON THE ARCHITECTURAL CHARACTER OF THE DEVELOPMENT • TO ENHANCE AND BUILD ON THE BIODIVERSITY OF THE IMMEDIATE AREA • TO ENHANCE AND BUILD ON HABITAT CONNECTIVITY TO ADJACENT NATURAL BUSHLAND • TO PROVIDE A SUSTAINABLE AND ATTRACTIVE EXTERNAL ENVIRONMENT FOR RESIDENTS TO ENJOY AND RECREATE • TO INCREASE BUSHFIRE SAFETY FOR THE DEVELOPMENT • TO ENHANCE AND BUILD ON THE VISUAL IMPACT OF THE

THE OVERALL DESIGN INTENT FOR THE LANDSCAPE PROPOSAL

ON THIS SITE WILL BE BASED AROUND SIX KEY PRINCIPLES;

ARCHITECTURAL ELEMENTS OF THE DEVELOPMENT WHEN VIEWED FROM THE COASTAL PLAIN THIS DESIGN INTENT WILL BE ACHIEVED THROUGH THE USE OF PREDOMINANTLY NATIVE ENDEMIC SPECIES, NATURAL CONTEXTUAL MATERIALS SUCH AS SANDSTONE, GREEN ROOF

AND TRELLISED CLIMBING PLANT DESIGN SOLUTIONS, A

SYMPATHETIC COLOUR PALETTE AND EFFICIENT USE OF EXISTING CLEARED GRASSLAND FOR THE MAJORITY OF THE CONSTRUCTED WORKS. IN ADDITION, MULCH WILL BE GENERATED FROM ON-SITE CLEARING WHERE POSSIBLE, TOPSOIL WILL BE STOCKPILED AND RE-USED AND NATURAL ROCK AND LOGS WITHIN THE

EXCAVATION ZONE WILL BE RE-LOCATED TO THE APZ FOR THE LANDSCAPE SETTING OF THIS DEVELOPMENT WILL BE THE FILTER THROUGH WHICH THE COMMUNITY WILL ULTIMATELY

VIEW THE SITE AND AS SUCH WILL PLAY A SIGNIFICANT ROLE IN

ITS PERCEPTION AS A VISUALLY SYMPATHETIC RESIDENTIAL COMPLEX IN A HIGHLY VISIBLE LOCATION. THE ILLAWARRA ESCARPMENT LANDSCAPE CONSERVATION AREA PROXIMITY WILL BE HONOURED THROUGH THE SELECTION

OF STRONG CHARACTER SPECIES SUCH AS TOONA CILIATA AND EUCALYPTUS SALIGNA AND ALSO THROUGH THE STRATIFIED NATURE OF THE SITE TERRACING THAT WILL REFLECT THE HORIZONTAL SANDSTONE CLIFF CHARACTER OF THE ESCARPMENT ABOVE THE COASTAL PLAIN.

THE SIX KEY PRINCIPLES HIGHLIGHTED ABOVE WILL BE APPLIED TOGETHER TO ACHIEVE THE GOAL OF A SUSTAINABLE AND BEAUTIFUL LANDSCAPE SOLUTION THAT SENSITIVELY SITS WITHIN ITS ESCARPMENT BACKDROP.

16.12.2019 DATE

VERIFIED ON SITE BEFORE CONSTRUCTION COMMENCE USE FIGURED DIMENSIONS IN PREFERENCE TO SCALE

VERIFY ALL DIMENSIONS ON SITE BEFORE CONSTRUCTION COMMENCES.


Development Application

DESCRIPTION

-KESTREL BUILDING 4

FIREFIGHTING WATER TANK

LANDSCAPE MASTERPLAN

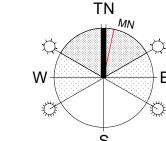

Keiraville NSW 2500

ııav	iraville, NSW, 2500								
		WOLLONGONG	NOWRA	BATEMANS BAY					
		T 02 4226 3600	T 02 4421 6822	T 02 4472 7388					
		W www.aej.com.au	E aej@aej.com.au						

ominated Architect Steven Bayer Reg. No. 5880

1
UE
01



SYMBOL	SCIENTIFIC NAME	COMMON NAME	MATURE H X W	POT SIZE	SPACING
CVGJ	Callistemon viminalis 'Green John'	Dwarf Bottlebrush	0.6 x 0.6 m	tube	4/m2
PAN	Pennisetum alopecuroides 'Nafray'	Swamp Foxtail	0.6 x 0.6 m	tube	5/m2
LFS	Lomandra fluviatilis 'Shara'	Mat Rush	0.55 x 0.5 m	tube	5/m2
LLT	Lomandra longifolia 'Tanika'	Mat Rush	0.5 x 0.6 m	tube	4/m2
WFM	Westringia fruticosa 'Mundi'	Coastal Rosemary	0.4 x 1.5 m	tube	2/m2
WFG	Westringia fruticosa 'Grey Box'	Coastal Rosemary	0.35 x 0.35 m	tube	4/m2
DCL	Dianella caerulea 'Lucia'	Blue Flax Lily	0.3 x 0.5 m	tube	5/m2
GHDG	Gazania hybrid 'Double Gold'	Gazania	0.2 x 0.6 m	tube	4/m2
CGAR	Carpobrotus glaucescens 'Aussie Rambler'	Pigface	0.2 x 2.0 m	tube	1.5/m2
MPY	Myoporum parvifolium 'Yareena'	Creeping Boobialla	0.1 x 1.0 m	tube	1.5/m2

SYMBOL	SCIENTIFIC NAME	COMMON NAME	MATURE H X W	POT SIZE	SPACIN
EM	Eucalyptus microcorys	Tallowood	40 x 15 m	200mm	specime
FM	Ficus macrophylla	Moreton Bay Fig	30 x 30 m	200mm	specime
CM	Corymbia maculata	Spotted Gum	30 x 10 m	200mm	specime
BA	Brachychiton acerifolious	Illawarra Flame Tree	25 x 12 m	200mm	specime
ES	Eucalyptus saligna	Sydney Bluegum	25 x 12 m	200mm	specime
ΑE	Alphitonia excelsa	Red Ash	20 x 10 m	200mm	specime
TC	Toona ciliata	Australian Red Cedar	40 x 8 m	200mm	specime
LA	Livistona australis	Cabbage Palm	25 x 5 m	200mm	specime
AS	Acmena smithii	Lilly Pilly	5 x 4 m	200mm	specime
XA	Xanthorrhoea australis	Grasstree	4 x 1.8 m	600 stem	specime
RC	Rhagodia candolleana	Seaberry Saltbush	1.5 x 1.5 m	tube	0.5/m2
LLT	Lomandra longifolia 'Tanika'	Mat Rush	0.5 x 0.6 m	tube	4/m2
CGAR	Carpobrotus glaucescens 'Aussie Rambler'	Pigface	0.2 x 2.0 m	tube	1.5/m2

INDICATIVE PLANTING SCHEDULE - PODIUM PLANTERS

INDICATIVE PLANTING SCHEDULE - GREEN ROOFS

SYMBOL	SCIENTIFIC NAME	COMMON NAME	MATURE H X W	POT SIZE	SPACING
APA	Acer palmatum 'Atropurpureum'	Japanese Maple	4 x 3 m	200mm	Specimen
AN	Asplenium nidus	Birds Nest Fern	0.7 x 1.5 m	200mm	.75/m2
SR	Strelitzia reginae	Bird of Paradise	1.5 x 1.0 m	200mm	1.5/m2
ВС	Blechnum cartilagineum	Fishbone Fern	1.0 x 1.0 m	200mm	1.5/m2
LFS	Lomandra fluviatilis 'Shara'	Mat Rush	0.55 x 0.5 m	200mm	5/m2
TJ	Trachelospermum jasminoides	Star Jasmine	4 x 2 m	200mm	1/linm
CGAR	Carpobrotus glaucescens 'Aussie Rambler'	Pigface	0.2 x 2.0 m	200mm	1.0/m2
MPY	Myoporum parvifolium 'Yareena'	Creeping Boobialla	0.1 x 1.0 m	200mm	1.5/m2
BS	Bougainvillea speciosa	Bougainvillea	5 x 5 m	200mm	0.5/linm
PT	Parthenocissus tricuspidata	Boston Ivy	5 x 4.0 m	200mm	0.5/linm
HV	Hardenbergia violacea	False sarsarparilla	1.5 x 1.5 m	tube	1.5/m2

INDICATIVE PLANTING SCHEDULE - INNER DEVELOPED LANDSCAPE AREA


SYMBOL	SCIENTIFIC NAME	COMMON NAME	MATURE H X W	POT SIZE	SPACING
BA	Brachychiton acerifolious	Illawarra Flame Tree	25 x 12 m	200mm	specimen
FB	Ficus benjamina	Weeping Fig	20 x 10 m	200mm	specimen
GR	Grevillea Robusta	Silky Oak	15 x 10 m	200mm	specimen
LA	Livistona australis	Cabbage Palm	25 x 5 m	200mm	specimen
AS	Acmena smithii	Lilly Pilly	5 x 4 m	200mm	specimen
APA	Acer palmatum 'Atropurpureum'	Japanese Maple	4 x 3 m	200mm	Specimen
DA	Dicksonia antarctica	Soft Treefern	6 x 3 m	800 stem	specimen
MA	Melaleuca armillaris	Bracelet Honey Myrtle	5 x 4 m	200mm	.25/m2
CG	Ceratopetalum gummiferum	NSW Christmas Bush	5 x 2 m	200mm	specimen
CA	Cyathea australis	Rough Treefern	4 x 3 m	800 stem	specimen
XA	Xanthorrhoea australis	Grasstree	4 x 1.8 m		specimen
RC	Rhagodia candolleana	Seaberry Saltbush	1.5 x 1.5 m	tube	0.5/m2
AN	Asplenium nidus	Birds Nest Fern	0.7 x 1.5 m	200mm	.75/m2
BS	Banksia spinulosa	Hairpin Banksia	0.5 x 1.5 m	200mm	0.5/m2
SR	Strelitzia reginae	Bird of Paradise	1.5 x 1.0 m	200mm	1.5/m2
BC	Blechnum cartilagineum	Fishbone Fern	1.0 x 1.0 m	200mm	1.5/m2
CVGJ	Callistemon viminalis 'Green John'	Dwarf Bottlebrush	0.6 x 0.6 m	tube	4/m2
PAN	Pennisetum alopecuroides 'Nafray'	Swamp Foxtail	0.6 x 0.6 m	tube	5/m2
LFS	Lomandra fluviatilis 'Shara'	Mat Rush	0.55 x 0.5 m	tube	5/m2
LLT	Lomandra longifolia 'Tanika'	Mat Rush	0.5 x 0.6 m	tube	4/m2
WFM	Westringia fruticosa 'Mundi'	Coastal Rosemary	0.4 x 1.5 m	tube	2/m2
WFG	Westringia fruticosa 'Grey Box'	Coastal Rosemary	0.35 x 0.35 m	tube	4/m2
DCL	Dianella caerulea 'Lucia'	Blue Flax Lily	0.3 x 0.5 m	tube	5/m2
GHDG	Gazania hybrid 'Double Gold'	Gazania	0.2 x 0.6 m	tube	4/m2
CGAR	Carpobrotus glaucescens 'Aussie Rambler'	Pigface	0.2 x 2.0 m	tube	1.5/m2
MPY	Myoporum parvifolium 'Yareena'	Creeping Boobialla	0.1 x 1.0 m	tube	1.5/m2
BS	Bougainvillea speciosa	Bougainvillea	5 x 5 m	200mm	0.5/linm
PT	Parthenocissus tricuspidata	Boston Ivy	5 x 4.0 m	200mm	0.5/linm
TJ	Trachelospermum jasminoides	Star Jasmine	4 x 2 m	200mm	1/linm
HV	Hardenbergia violacea	False sarsarparilla	1.5 x 1.5 m	tube	1.5/m2



4 Kestrel Podium DA/51 1:200 GREEN ROOF OVER SEAEAGLE BUILDING — - BATTERED AND PLANTED EAGLESNEST PARK 3 Landscape Section 1 DA/51 1:200 - RETAINING WALLS

COPYRIGHT OF TILMENT PTY LTD (ACN 003 163 trading as EDMISTON JONES GBB © 2019 LEVELS SHOWN ON PLAN ARE APPROXIMATE ONLY AND SHALL BE VERIFIED ON SITE BEFORE CONSTRUCTION COMMENCES. USE FIGURED DIMENSIONS IN PREFERENCE TO SCALE. VERIFY ALL DIMENSIONS ON SITE BEFORE CONSTRUCTION COMMENCES. 16.12.2019 1 Development Application DESCRIPTION DATE

PART LANDSCAPE PLAN 1

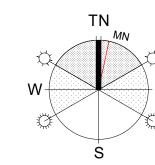

For Surewin Parkview Pty Ltd | Proposed Residential Development THE COSGROVE At Lot 90 in D.P. 1086429, 14 Cosgrove Avenue, Keiraville, NSW, 2500

W www.aej.com.au **E** aej@aej.com.au

T 02 4226 3600 T 02 4421 6822 T 02 4472 7388

AND FOOTINGS TO ENGINEERS DETAILS

DRAWING TITLE: Part Landscape Plan 1 CHECKED: DATE: SCALE: @ B1 DRAWN: SS 17-0049

SCHEDULE OF LANDSCAPE

REQUIREMENTS

41,934 sqm

36,753 sqm

11,026 sqm

5,513 sqm

21,209 sqm

15,370 sqm

2893 sqm

EX. TREES TO BE RETAINED

10M DIAM. FEATURE

6M DIAM. TREES < 8M HIGH

2M DIAM SHRUBS < 3M HIGH

1M DIAM SHRUBS & PERENNIALS < 1.2M

GROUNDCOVERS < 0.3M HIGH

LAWN AREAS

GREEN ROOF

TRACKS

APZ MAINTENANCE

STORMWATER PIT

WATER TANKS

APZ BOUNDARY

LANDSCAPE ELEMENTS

LEGEND

PEDESTRIAN FOOTPATH TO COSGROVE AVE

ASSET PROTECTION ZONE (APZ) EAGLES NEST PARK COS ZONE

FITNESS TRAIL LOCATION 1

SHELTER & BBQ ZONE

COS PODIUM

E2 ZONE BOUNDARY

EXISTING CONTOURS

PAVING

TREES < 15M HIGH

DCP REQUIREMENTS

SITE AREA (EXCL. E2 ZONE)

(30% OF SITE AREA EXCL. E2 ZONE)

REQUIRED DEEP SOIL ZONE (DSZ)

PROPOSED LANDSCAPE AREAS

(15% OF SITE AREA EXCL. E2 ZONE)

REQUIRED COMMUNAL OPEN SPACE (COS)

LANDSCAPE SYMBOLS LEGEND

REQUIRED LANDSCAPE

(5M2 X 47 UNITS)

LANDSCAPE (INCL. APZ)

DEEP SOIL ZONE (INCL. APZ)

COMMUNAL OPEN SPACE

SITE AREA

16.12.2019



INDICATIVE PLANTING SCHEDULE - INNER DEVELOPED LANDSCAPE AREA MATURE H X W POT SIZESPACING SYMBOL SCIENTIFIC NAME Brachychiton acerifolious Illawarra Flame Tree 25 x 12 m 200mm specimen Ficus benjamina Weeping Fig 200mm specimen Grevillea Robusta 200mm specimen Livistona australis Cabbage Palm 200mm specimen Acmena smithii Lilly Pilly 200mm specimen 5 x 4 m Acer palmatum 'Atropurpureum' 200mm Specimen Dicksonia antarctica 800 stem specimen Bracelet Honey Myrtle 200mm .25/m2 Melaleuca armillaris NSW Christmas Bush Ceratopetalum gummiferum 200mm specimen Cyathea australis Rough Treefern 800 stem specimen Xanthorrhoea australis Rhagodia candolleana Asplenium nidus Birds Nest Fern Hairpin Banksia 0.5 x 1.5 m Banksia spinulosa Strelitzia reginae 1.5 x 1.0 m Blechnum cartilagineum Fishbone Fern Callistemon viminalis 'Green John' 0.6 x 0.6 m Swamp Foxtail 0.6 x 0.6 m tube Pennisetum alopecuroides 'Nafray' 0.55 x 0.5 m tube Lomandra fluviatilis 'Shara' Lomandra longifolia 'Tanika' Westringia fruticosa 'Mundi' Mat Rush 0.5 x 0.6 m tube Coastal Rosemary Westringia fruticosa 'Grey Box' 0.35 x 0.35 m tube Coastal Rosemary 0.3 x 0.5 m tube 0.2 x 0.6 m tube 0.2 x 2.0 m tube Dianella caerulea 'Lucia' Gazania hybrid 'Double Gold' Blue Flax Lily Carpobrotus glaucescens 'Aussie Rambler' 0.1 x 1.0 m tube 1.5/m2 Myoporum parvifolium 'Yareena' Creeping Boobialla Bougainvillea speciosa 5 x 4.0 m Parthenocissus tricuspidata Boston Ivy Star Jasmine Trachelospermum jasminoides 1.5 x 1.5 m tube False sarsarparilla Hardenbergia violacea INDICATIVE PLANTING SCHEDULE - PODIUM PLANTERS

SYMBOL	SCIENTIFIC NAME	COMMON NAME	MATURE H X W	POT SIZE	SPACING
APA	Acer palmatum 'Atropurpureum'	Japanese Maple	4 x 3 m	200mm	Specimen
AN	Asplenium nidus	Birds Nest Fern	0.7 x 1.5 m	200mm	.75/m2
SR	Strelitzia reginae	Bird of Paradise	1.5 x 1.0 m	200mm	1.5/m2
BC	Blechnum cartilagineum	Fishbone Fern	1.0 x 1.0 m	200mm	1.5/m2
LFS	Lomandra fluviatilis 'Shara'	Mat Rush	0.55 x 0.5 m	200mm	5/m2
TJ	Trachelospermum jasminoides	Star Jasmine	4 x 2 m	200mm	1/linm
CGAR	Carpobrotus glaucescens 'Aussie Rambler'	Pigface	0.2 x 2.0 m	200mm	1.0/m2
MPY	Myoporum parvifolium 'Yareena'	Creeping Boobialla	0.1 x 1.0 m	200mm	1.5/m2
BS	Bougainvillea speciosa	Bougainvillea	5 x 5 m	200mm	0.5/linm
PT	Parthenocissus tricuspidata	Boston Ivy	5 x 4.0 m	200mm	0.5/linm
HV	Hardenbergia violacea	False sarsarparilla	1.5 x 1.5 m	tube	1.5/m2


INDICATIVE PLANTING SCHEDULE - GREEN ROOFS

SYMBOL	SCIENTIFIC NAME	COMMON NAME	MATURE H X W	POT SIZE	SPACING
CVGJ	Callistemon viminalis 'Green John'	Dwarf Bottlebrush	0.6 x 0.6 m	tube	4/m2
PAN	Pennisetum alopecuroides 'Nafray'	Swamp Foxtail	0.6 x 0.6 m	tube	5/m2
LFS	Lomandra fluviatilis 'Shara'	Mat Rush	0.55 x 0.5 m	tube	5/m2
LLT	Lomandra longifolia 'Tanika'	Mat Rush	0.5 x 0.6 m	tube	4/m2
WFM	Westringia fruticosa 'Mundi'	Coastal Rosemary	0.4 x 1.5 m	tube	2/m2
WFG	Westringia fruticosa 'Grey Box'	Coastal Rosemary	0.35 x 0.35 m	tube	4/m2
DCL	Dianella caerulea 'Lucia'	Blue Flax Lily	0.3 x 0.5 m	tube	5/m2
GHDG	Gazania hybrid 'Double Gold'	Gazania	0.2 x 0.6 m	tube	4/m2
CGAR	Carpobrotus glaucescens 'Aussie Rambler'	Pigface	0.2 x 2.0 m	tube	1.5/m2
MPY	Myoporum parvifolium 'Yareena'	Creeping Boobialla	0.1 x 1.0 m	tube	1.5/m2



Section 11 - Bowerbird Podium


DA/52 1:200

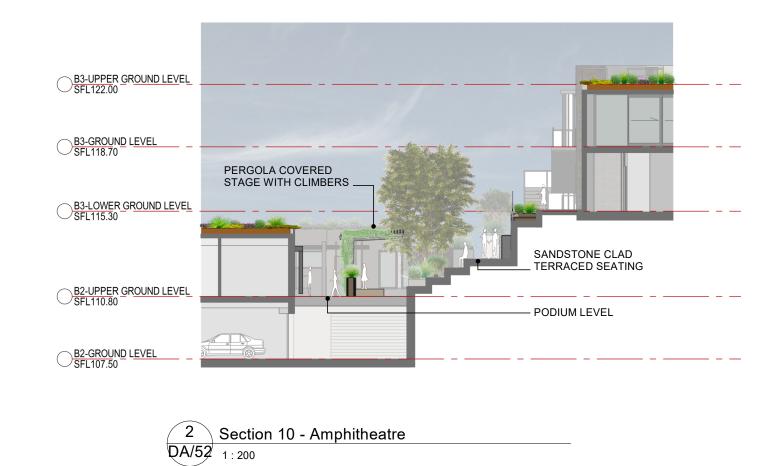

INDICATIVE PLANTING SCHEDULE - APZ/MANAGED BUSHLAND							
SYMBOL	SCIENTIFIC NAME	COMMON NAME	MATURE H X W	POT SIZE	SPACING		
EM	Eucalyptus microcorys	Tallowood	40 x 15 m	200mm	specimen		
FM	Ficus macrophylla	Moreton Bay Fig	30 x 30 m	200mm	specimen		
CM	Corymbia maculata	Spotted Gum	30 x 10 m	200mm	specimen		
BA	Brachychiton acerifolious	Illawarra Flame Tree	25 x 12 m	200mm	specimen		
ES	Eucalyptus saligna	Sydney Bluegum	25 x 12 m	200mm	specimen		
AE	Alphitonia Excelsa	Red Ash	20 x 10 m	200mm	specimen		
TC	Toona ciliata	Australian Red Cedar	40 x 8 m	200mm	specimen		
LA	Livistona australis	Cabbage Palm	25 x 5 m	200mm	specimen		
AS	Acmena smithii	Lilly Pilly	5 x 4 m	200mm	specimen		
XA	Xanthorrhoea australis	Grasstree	4 x 1.8 m	600 stem	specimen		
RC	Rhagodia candolleana	Seaberry Saltbush	1.5 x 1.5 m	tube	0.5/m2		
LLT	Lomandra longifolia 'Tanika'	Mat Rush	0.5 x 0.6 m	tube	4/m2		
CGAR	Carpobrotus glaucescens 'Aussie Rambler'	Pigface	0.2 x 2.0 m	tube	1.5/m2		

	1.200				
	COPYRIGHT OF TILMENT PTY LTD (ACN 003 163				
	451) trading as EDMISTON JONES GBB © 2019				
	trading as Ebinio Fort Contes GBB @ 2015	l_			
		Z			
AM	THIS DRAWING ALWAYS REMAINS THE COPYRIGHT OF EDMISTON JONES GBB AND SHALL NOT BE USED OTHER THAN FOR THE	0			
:58	PROJECT INTENDED WITHOUT WRITTEN AUTHORITY.	<u>S</u>			
.38	LEVELS SHOWN ON PLAN ARE APPROXIMATE ONLY AND SHALL BE VERIFIED ON SITE BEFORE CONSTRUCTION COMMENCES.	>			
	USE FIGURED DIMENSIONS IN PREFERENCE TO SCALE.	Щ			
019	VERIFY ALL DIMENSIONS ON SITE BEFORE CONSTRUCTION	2			
12/20	COMMENCES.				
6/1			1	Development Application	16.12.2019
_			REV.	DESCRIPTION	DATE

PART LANDSCAPE PLAN 2

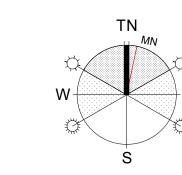

sed Residential Development OSGROVE
90 in D.P. 1086429, 14 Cosgrove Aver lle, NSW, 2500

At Lot 90 in D.P. 1086429, 14 Cosgrove Av Keiraville, NSW, 2500									
-		WOLLONGONG T 02 4226 3600	NOWRA T 02 4421 6822	BATEMANS BA T 02 4472 7388					
_		W www.aej.com.au	E aej@aej.com.au						

1	0 1 2 3 4 5	6 7	8 9	10 11	12 13	14 15	16 17	18 1				
	DRAWING TITLE: Part Landscape Plan 2											
nue,	SCALE: @ B1 As indicated	DRAWN: EJ		CHEC	KED:		DATE: 16.12.201					
	PROJECT No:	DWG No:			ISSUI	E:						
	17-0049			DA/52				1				

SCHEDULE OF LANDSCAPE

REQUIREMENTS

41,934 sqm

36,753 sqm

11,026 sqm

5,513 sqm

21,209 sqm

15,370 sqm

2893 sqm

EX. TREES TO BE

10M DIAM. FEATURE

RETAINED

< 15M HIGH

6M DIAM. TREES < 8M HIGH

2M DIAM SHRUBS

1M DIAM SHRUBS & PERENNIALS < 1.2M

GROUNDCOVERS < 0.3M HIGH

< 3M HIGH

CLIMBERS

LAWN AREAS

GREEN ROOF

APZ MAINTENANCE

STORMWATER PIT

WATER TANKS

APZ BOUNDARY

E2 ZONE BOUNDARY

EXISTING CONTOURS

LANDSCAPE ELEMENTS

LEGEND

ASSET PROTECTION ZONE (APZ)

COMMUNAL VEGETABLE GARDEN

PEDESTRIAN FOOTPATH TO COSGROVE AVE

FITNESS TRAIL LOCATION 2

CENTRAL COS ZONE

COS PODIUM

STAGE & SHELTER

PAVING

DCP REQUIREMENTS

REQUIRED LANDSCAPE

(5M2 X 47 UNITS)

SITE AREA (EXCL. E2 ZONE)

(30% OF SITE AREA EXCL. E2 ZONE)

(15% OF SITE AREA EXCL. E2 ZONE)

REQUIRED COMMUNAL OPEN SPACE (COS)

LANDSCAPE SYMBOLS LEGEND

REQUIRED DEEP SOIL ZONE (DSZ)


PROPOSED LANDSCAPE AREAS


LANDSCAPE (INCL. APZ)

COMMUNAL OPEN SPACE

DEEP SOIL ZONE (INCL. APZ)

SITE AREA

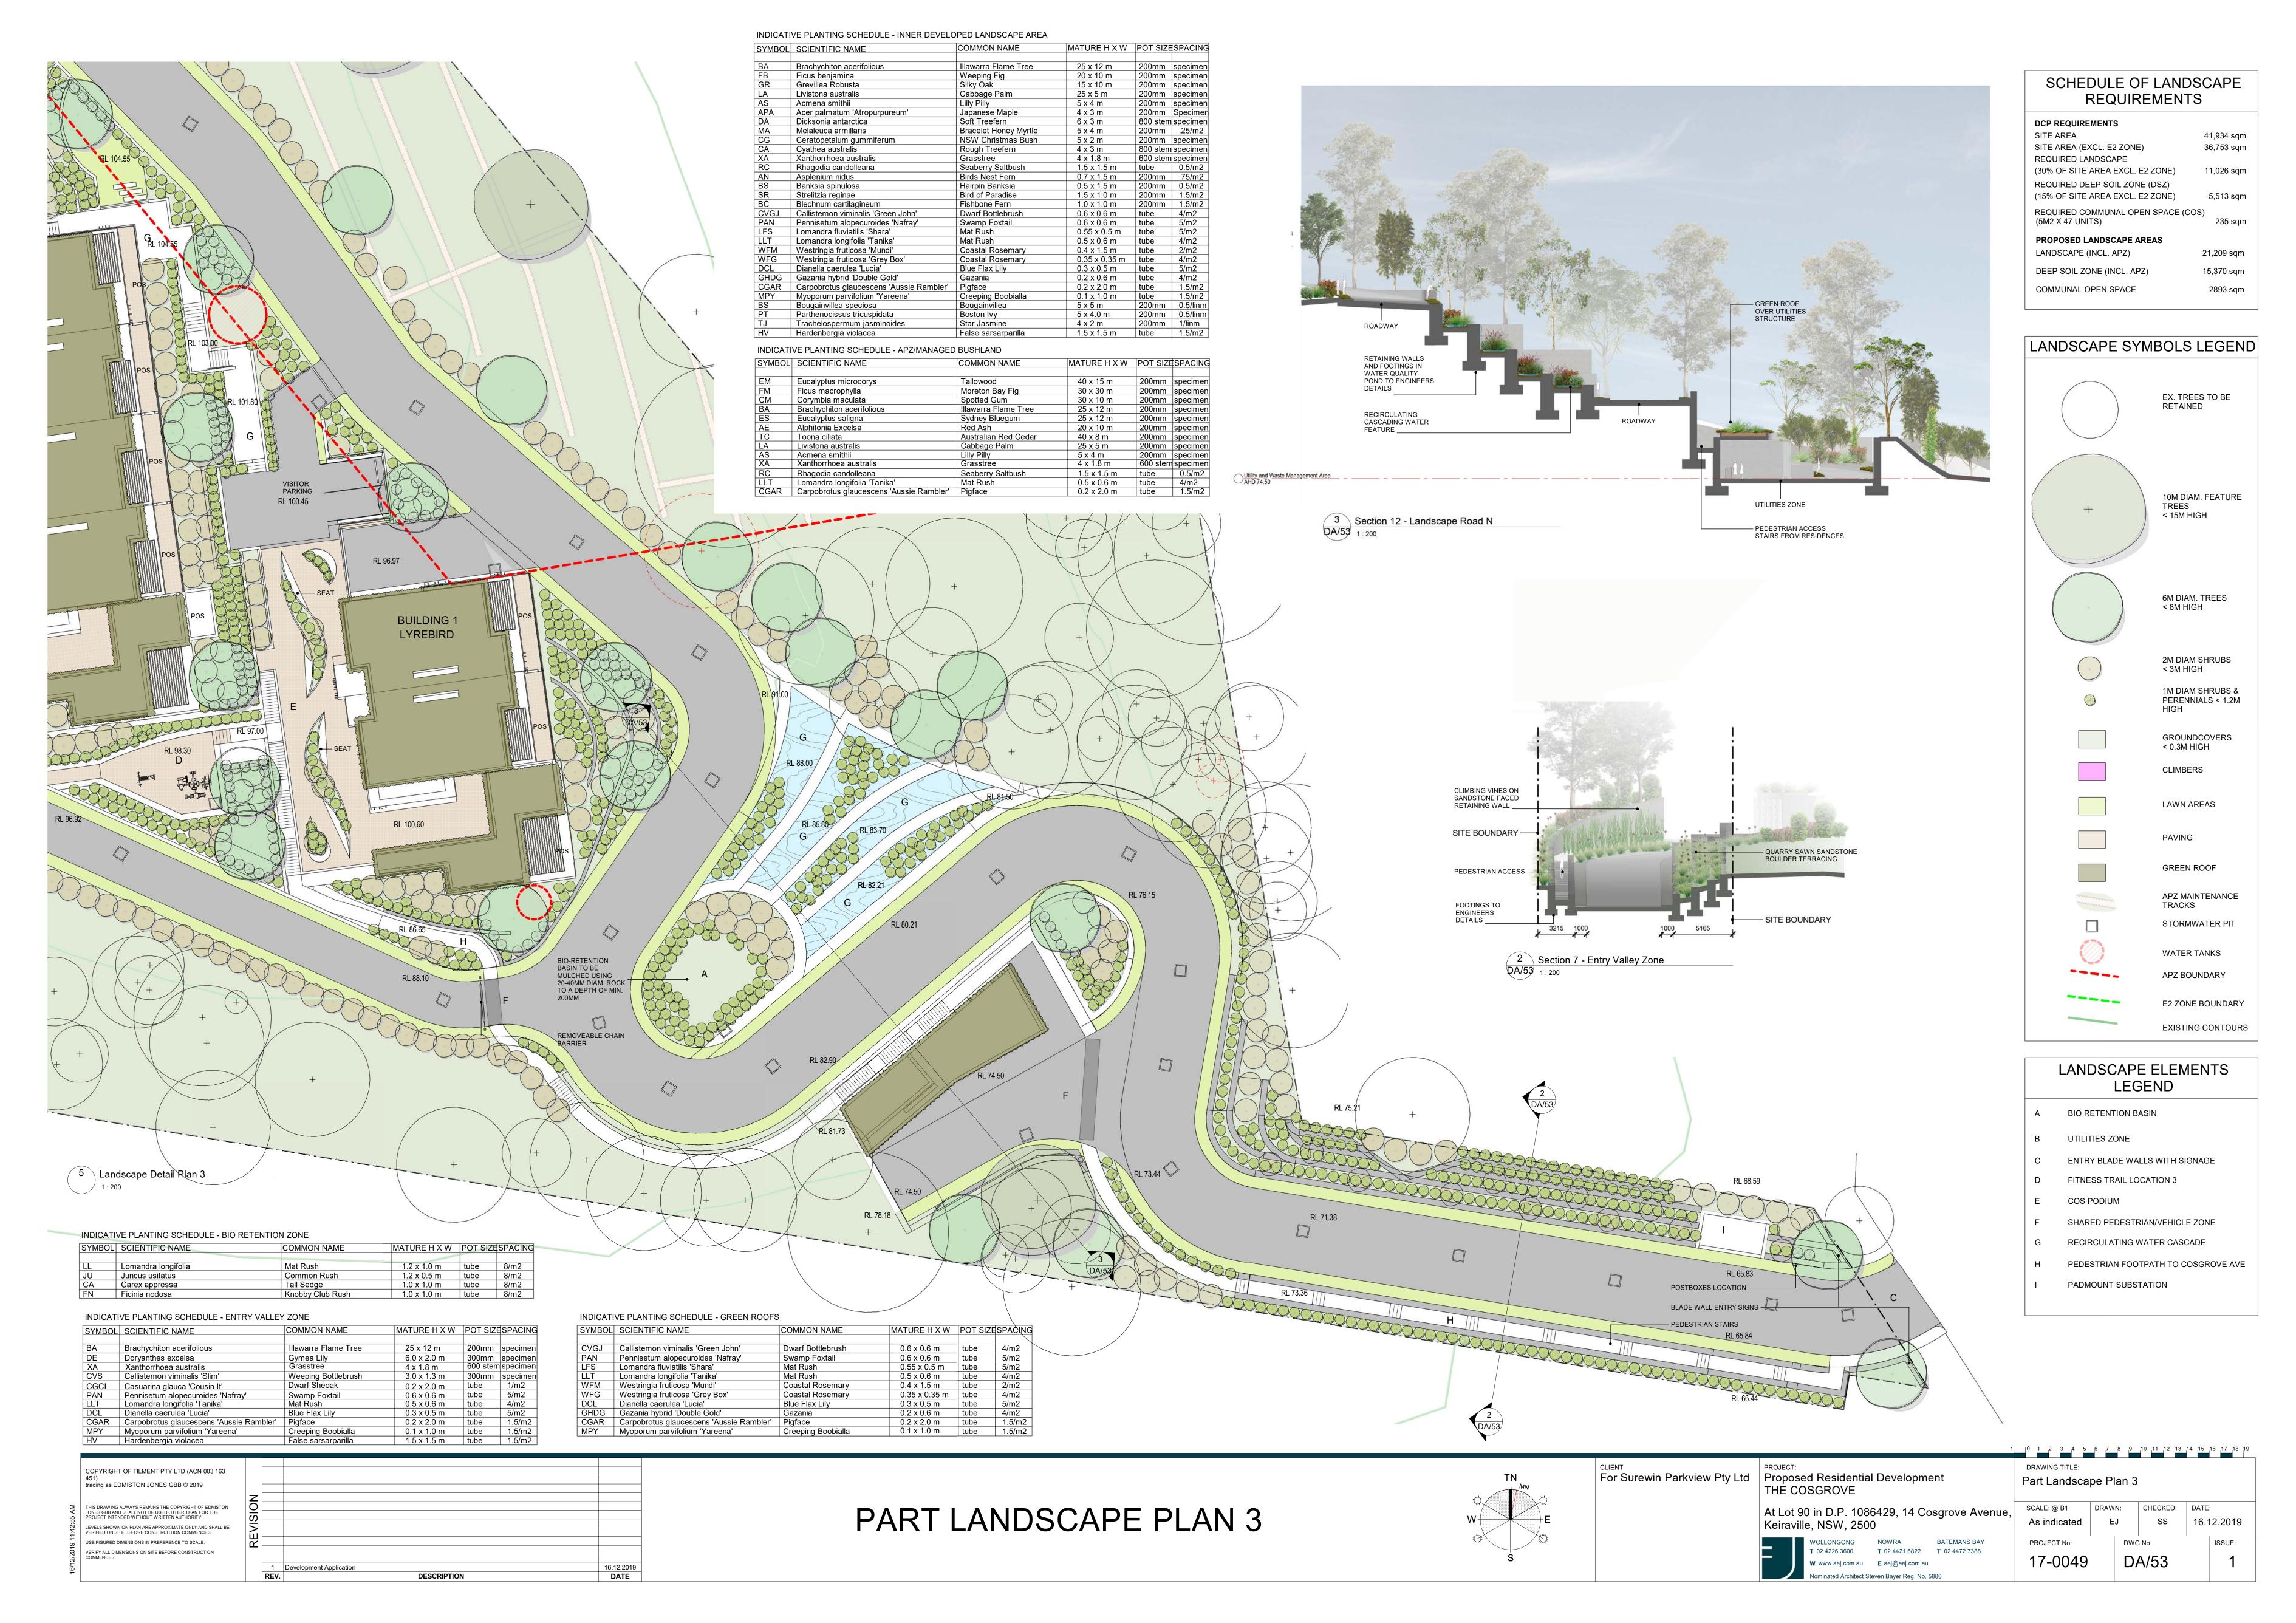

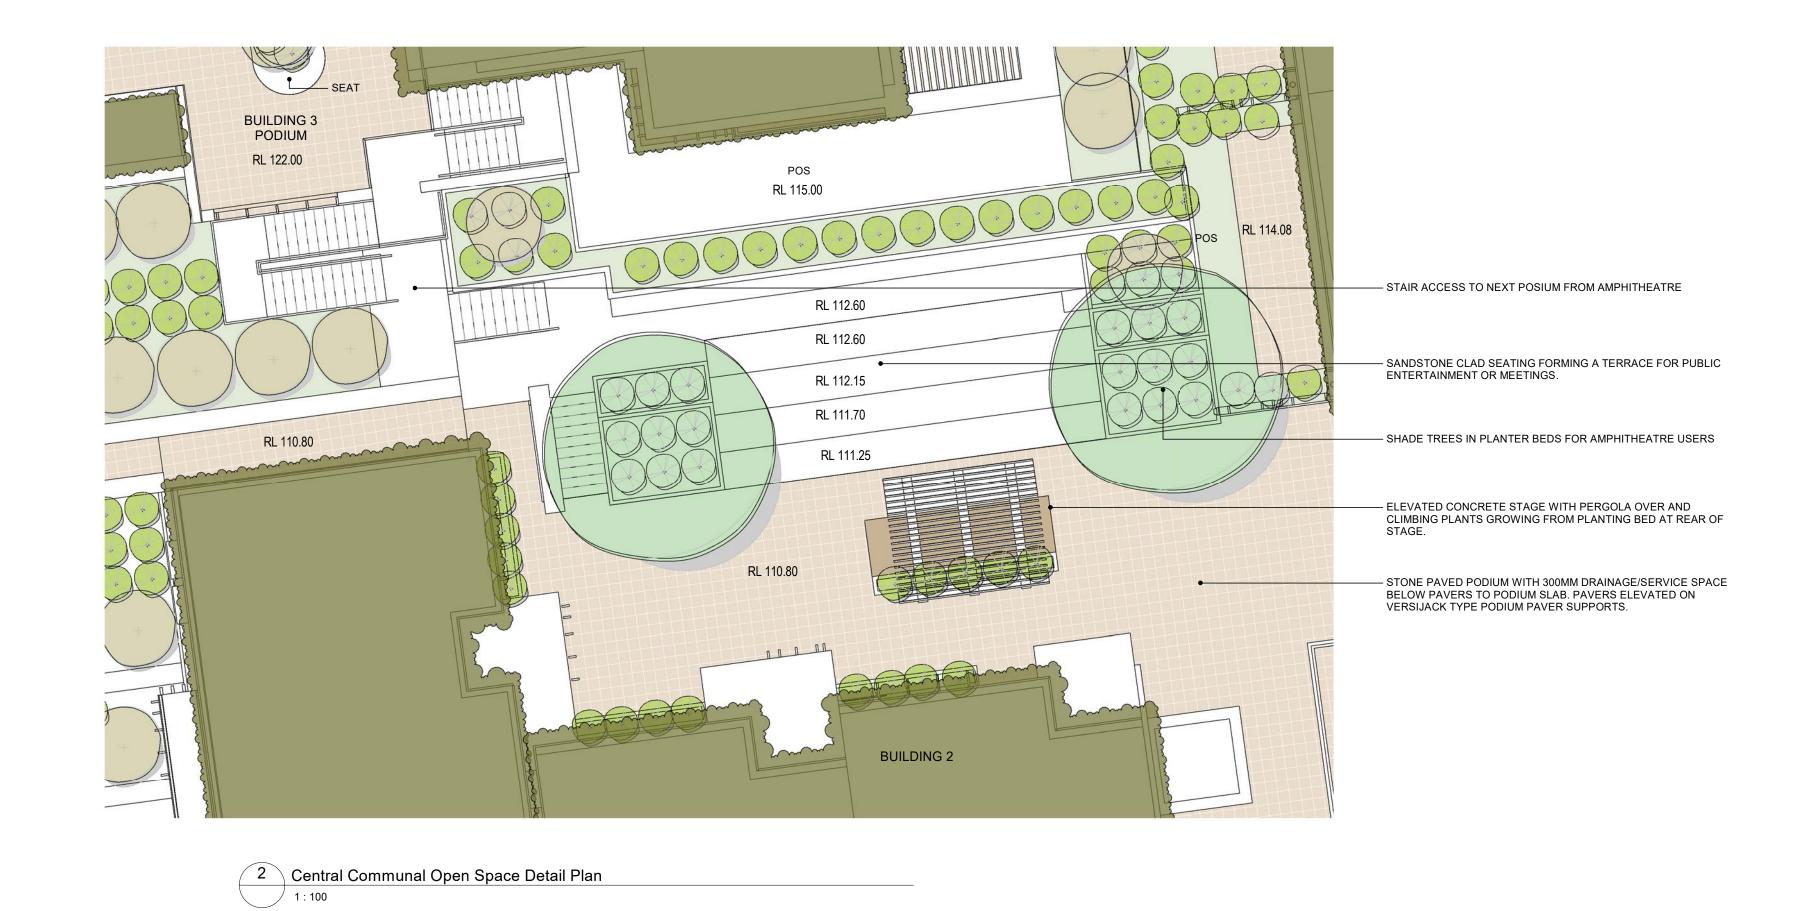







1 Central Communal Open Space Perspective



Eaglesnest Communal Open Space Perspe

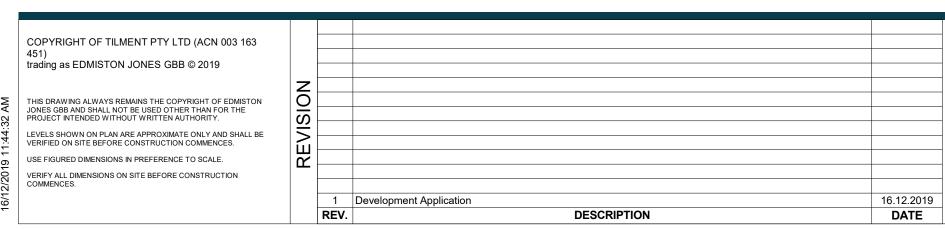

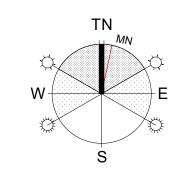


CLIENT
For Surewin Parkview Pty Ltd

ROJECT: Proposed Residential Development THE COSGROVE						
At Lot 90 in D.P. 1086429, 14 Cosgrove Avenue, Keiraville, NSW, 2500						
WOLLONGONG NOWRA BATEMANS BAY						


T 02 4226 3600 T 02 4421 6822 T 02 4472 7388

	PROJECT No:		DWG	S No:				SSUE:	_
,	SCALE: @ B1 1:100	DRAW L		CHE	ECKED: SS		ATE: 6.12	.2019)
	drawing title: Communal O	pen (Spac	e					

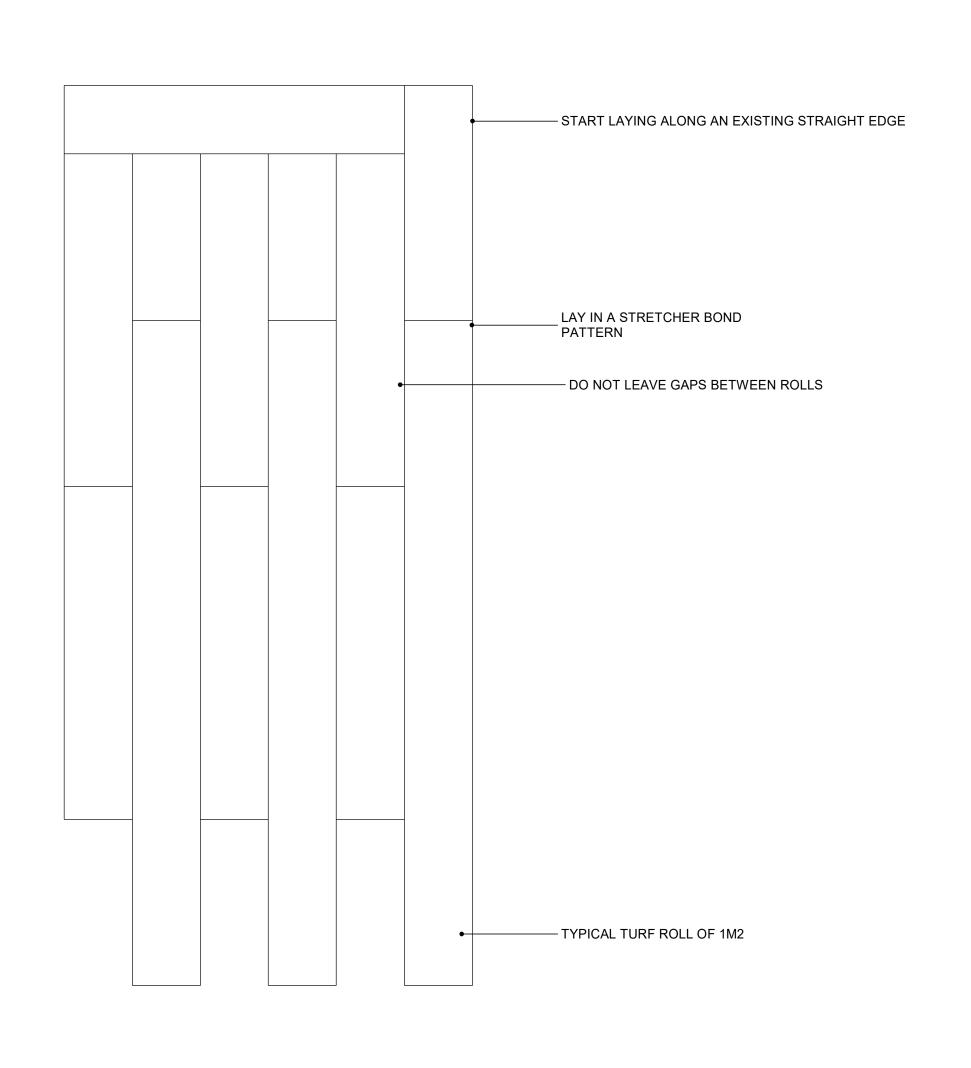

STANDARD GALVANISED TEMPORARY FENCING PANELS INSTALLED ALONG PERIMETER OF DRIPLINE OF TREES TO 75MM DEPTH RECYCLED HARDWOOD FLAKE/LEAF/CHIP MULCH TO BE LAID THROUGHOUT FENCED AREA AND MAINTAINED DURING CONSTRUCTION


TYPICAL PROTECTIVE FENCING DETAIL 1:25

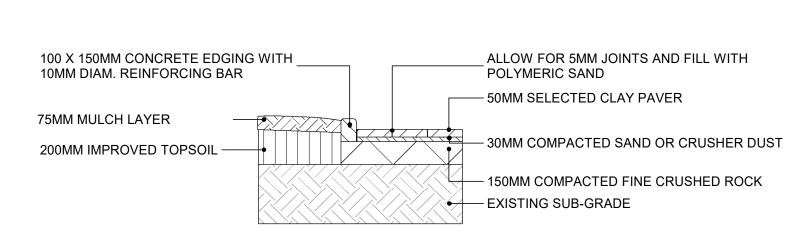

PLANTING HOLE TO BE 150MM WIDER - THAN ROOTBALL WITH SIDES EXISTING SUB-GRADE BROKEN UP PRIOR TO PLANTING. **CULTIVATE SUBGRADE TO 100MM** BACKFILL WITH APPROVED SOIL AS DEPTH AND MIX WITH BACKFILLED TYPICAL PAVING DETAIL TYPICAL TREE PLANTING DETAIL NTS

MOUND MULCH TO BASE OF TRUNK TO

NATURAL GROUND LEVEL -

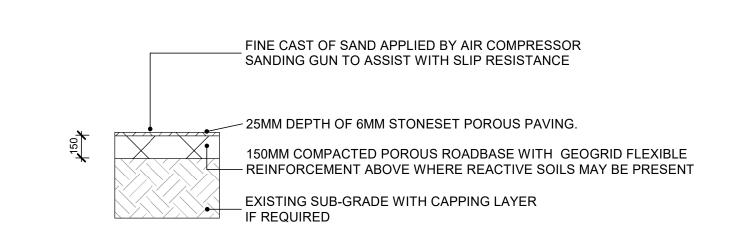

— ECO-CERTIFIED HARDWOOD SLATS

• SEAT LENGTH 1750 • CAST ALUMINIUM BASE TO BE DYNABOLTED TO CONCRETE

- ALLOW FOR 5MM JOINT GAP AND FILL WITH POLYMERIC SAND

FOOTINGS OR SLAB
• POWDER COATED FINISH TO ALUMINIUM BASE • JARRAH HARDWOOD BATTENS WITH AN OILED FINISH

- 50MM SELECTED CLAY PAVER


- 30MM COMPACTED SAND OR CRUSHER DUST

- 150MM COMPACTED FINE CRUSHED ROCK

- CAST ALUMINIUM BASE

TYPICAL SFA SEAT

1:25

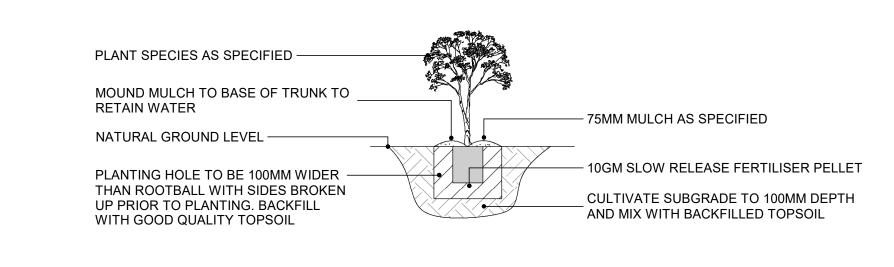


HARDWOOD STAKE 38 X 38 X 1500 HAMMERED INTO SOIL UNTIL SECURE

HESSIAN WEBBING 50MM WIDE STAPLED TO HARDWOOD STAKE

75MM DEPTH MULCH AS SPECIFIED

✓ 2 X 10GM SLOW RELEASE FERTILISER

TYPICAL TURF DETAIL PATTERN 1:25

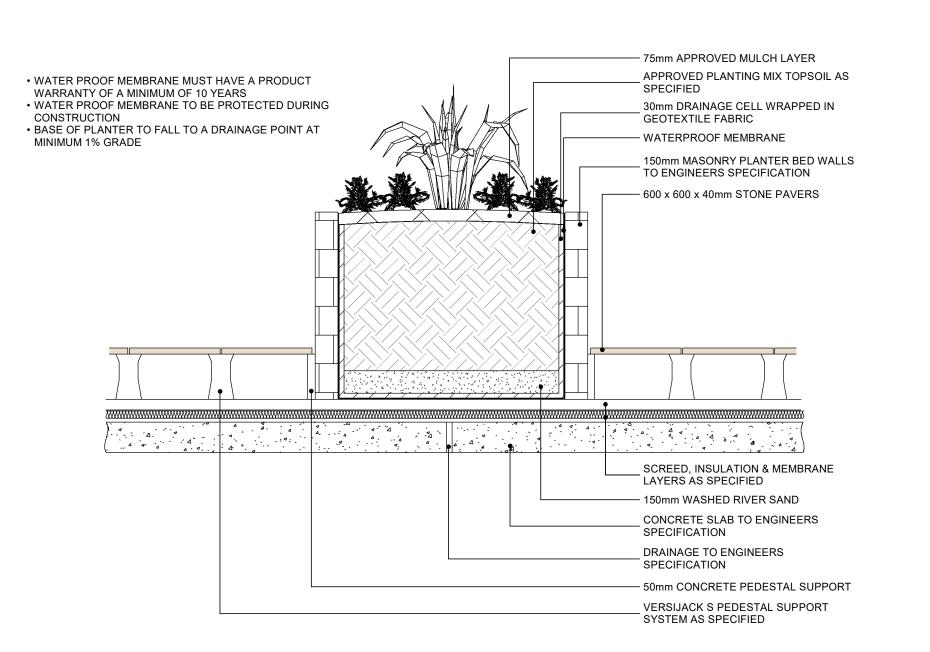


TYPICAL RAISED PLANTER ON SLAB DETAIL

1:25

TYPICAL CONCRETE BED EDGE DETAIL 1:25



TYPICAL SHRUB PLANTING DETAIL NTS

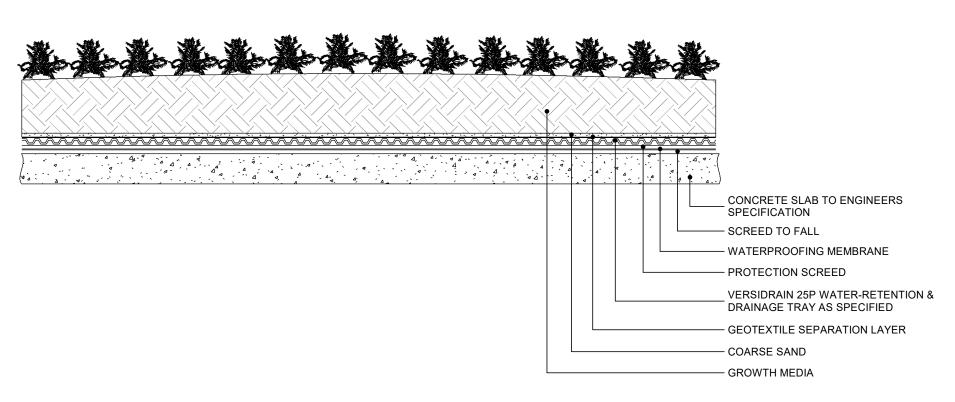

TYPICAL GREEN ROOF DETAIL 1:25

APZ/MANAGED BUSHLAND 1. REMOVAL OF IDENTIFIED WEEDS 2. WHIPPERSNIPPING OF REMAINING GR TO A MAXIMUM SWARD HEIGHT OF 1 3. CROWNLIFTING OF EXISTING RETAIN 4. HAND IRRIGATION OF NEW PLANTING UNTIL ESTABLISHED. AS REQUIRED A INNER DEVELOPED LANDSCAPE ARE



MAINTENANCE SCHEDULE INTENT

UNTIL ESTABLISHED. AS REQUIRED AF 4. MAINTAINING MULCH AT 75MM DEPTH **GREEN ROOFS**

- 1. REMOVAL OF WEEDS AS REQUIRED 2. REPLACEMENT OF FAILED PLANTINGS 3. SPRINKLER DRENCHING IRRIGATION (THEN MONTHLY UNTIL ESTABLISHED. 4. MAINTAINING GROWTH MEDIA DEPTH
- **BIO-RETENTION ZONE**
- 1. REMOVAL OF WEEDS AS REQUIRED 2. REPLACEMENT OF FAILED PLANTINGS 3. MAINTAIN STONE MULCH AS REQUIRE
- 4. REMOVE ALGAL GROWTH OR EXCESS

FREQUENCY

;	 REMOVAL OF IDENTIFIED WEEDS WHIPPERSNIPPING OF REMAINING GRASSLAND BETWEEN MAINTENANCE ACCESS TRACKS TO A MAXIMUM SWARD HEIGHT OF 100MM CROWNLIFTING OF EXISTING RETAINED TREES TO 2M ABOVE GROUND LEVEL HAND IRRIGATION OF NEW PLANTINGS ON A WEEKLY BASIS FOR 4 WEEKS AND THEN MONTHLY UNTIL ESTABLISHED. AS REQUIRED AFTER ESTABLISHMENT. 	QUARTERLY HALF YEARLY ANNUALLY WEEKLY/MONTHLY/AS REQUIRED
	INNER DEVELOPED LANDSCAPE AREA, ENTRY VALLEY ZONE, PODIUM PLANTERS	
;	 REMOVAL OF WEEDS AS REQUIRED REPLACEMENT OF FAILED PLANTINGS HAND IRRIGATION OF NEW PLANTINGS ON A WEEKLY BASIS FOR 4 WEEKS AND THEN MONTHLY UNTIL ESTABLISHED. AS REQUIRED AFTER ESTABLISHMENT. MAINTAINING MULCH AT 75MM DEPTH 	MONTHLY HALF YEARLY WEEKLY/MONTHLY/AS REQUIRED ANNUAL
	GREEN ROOFS	
;	GREEN ROOFS 1. REMOVAL OF WEEDS AS REQUIRED 2. REPLACEMENT OF FAILED PLANTINGS 3. SPRINKLER DRENCHING IRRIGATION OF NEW PLANTINGS ON A WEEKLY BASIS FOR 4 WEEKS AND THEN MONTHLY UNTIL ESTABLISHED. AS REQUIRED AFTER ESTABLISHMENT. 4. MAINTAINING GROWTH MEDIA DEPTH AS REQUIRED	MONTHLY HALF YEARLY WEEKLY/MONTHLY/AS REQUIRED ANNUAL
;	 REMOVAL OF WEEDS AS REQUIRED REPLACEMENT OF FAILED PLANTINGS SPRINKLER DRENCHING IRRIGATION OF NEW PLANTINGS ON A WEEKLY BASIS FOR 4 WEEKS AND THEN MONTHLY UNTIL ESTABLISHED. AS REQUIRED AFTER ESTABLISHMENT. 	HALF YEARLY WEEKLY/MONTHLY/AS REQUIRED
•	 REMOVAL OF WEEDS AS REQUIRED REPLACEMENT OF FAILED PLANTINGS SPRINKLER DRENCHING IRRIGATION OF NEW PLANTINGS ON A WEEKLY BASIS FOR 4 WEEKS AND THEN MONTHLY UNTIL ESTABLISHED. AS REQUIRED AFTER ESTABLISHMENT. MAINTAINING GROWTH MEDIA DEPTH AS REQUIRED 	HALF YEARLY WEEKLY/MONTHLY/AS REQUIRED

ominated Architect Steven Bayer Reg. No. 5880

This drawing always remains the copyright of edmiston Jones gbb and shall not be used other than for the PROJECT INTENDED WITHOUT WRITTEN AUTHORITY.	6/12/2019 11:44:4	LEVELS SHOWN ON PLAN ARE APPROXIMATE ONLY AND SHALL BE VERIFIED ON SITE BEFORE CONSTRUCTION COMMENCES. USE FIGURED DIMENSIONS IN PREFERENCE TO SCALE. VERIFY ALL DIMENSIONS ON SITE BEFORE CONSTRUCTION COMMENCES.	REVIS		
THIS DRAWING ALWAYS REMAINS THE COPYRIGHT OF EDMISTON JONES GBB AND SHALL NOT BE USED OTHER THAN FOR THE PROJECT INTENDED WITHOUT WRITTEN AUTHORITY.	719 11:4	VERIFIED ON SITE BEFORE CONSTRUCTION COMMENCES. USE FIGURED DIMENSIONS IN PREFERENCE TO SCALE.			
	4:41 AM	JONES GBB AND SHALL NOT BE USED OTHER THAN FOR THE PROJECT INTENDED WITHOUT WRITTEN AUTHORITY.	<u>o</u>		

DRAWING TITLE: For Surewin Parkview Pty Ltd | Proposed Residential Development Landscape Typical Details THĖ COSGROVE CHECKED: DATE: At Lot 90 in D.P. 1086429, 14 Cosgrove Avenue, 16.12.2019 SS Keiraville, NSW, 2500 VOLLONGONG NOWRA BATEMANS BAY PROJECT No: T 02 4226 3600 T 02 4421 6822 T 02 4472 7388 17-0049 DA/55 W www.aej.com.au E aej@aej.com.au











Fitness Trail Location Perspective

Rosella Podium Building 2 North-East Perspective

	COPYRIGHT OF TILMENT PTY LTD (ACN 003 163 451) trading as EDMISTON JONES GBB © 2019			
:47:23 AM	THIS DRAWING ALWAYS REMAINS THE COPYRIGHT OF EDMISTON JONES GBB AND SHALL NOT BE USED OTHER THAN FOR THE PROJECT INTENDED WITHOUT WRITTEN AUTHORITY. LEVELS SHOWN ON PLAN ARE APPROXIMATE ONLY AND SHALL BE VEDICINED ON SITE BEEDE CONSTRUCTION COMMENCES	<u> </u>		
19 11	USE FIGURED DIMENSIONS IN PREFERENCE TO SCALE. VERIFY ALL DIMENSIONS ON SITE BEFORE CONSTRUCTION COMMENCES.	법 		
16/12/20		1 RE	Development Application V. DESCRIPTION	16.12.2019 DATE

LANDSCAPE PERSPECTIVES


For Surewin Parkview Pty Ltd	PROJECT: Proposed Residential Develo THE COSGROVE
------------------------------	---

THE COSGROVE	
At Lot 90 in D.P. 1086429, 14 Cosgrove Avenue, Keiraville, NSW, 2500	

) V 🗀			
P. 108 V, 250		osgrove Avenue,	SCALE: @ B1
GONG	NOWRA	BATEMANS BAY	PROJECT No:
3600			

Landscape Perspectives									
SCALE: @ B1 DRAWN: CHECKED: DATE:									
LF SS 16.12.2019									
PROJECT No: DWG No: ISSUE:									
17-0049									

DRAWING TITLE:

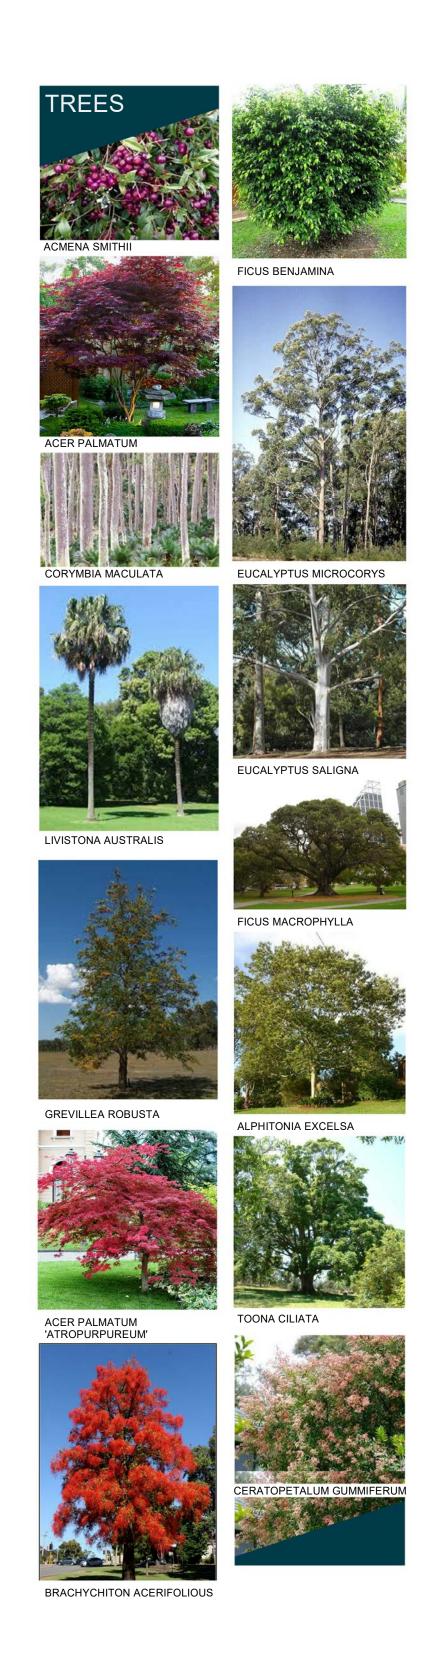















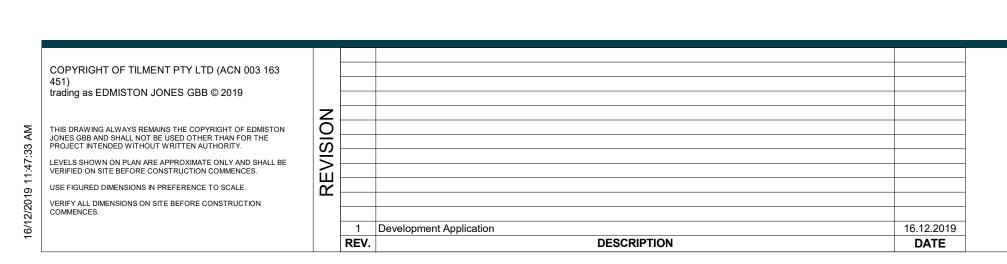

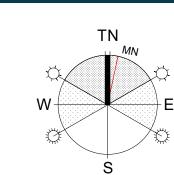




For Surewin Parkview Pty Ltd Proposed Residential Development THE COSGROVE + 00 in D D 1006420 14 Co

0 in D.P. 1086 e, NSW, 2506	,	sgrove A
WOLLONGONG T 02 4226 3600	NOWRA T 02 4421 6822	BATEMANS E T 02 4472 738
W www.aej.com.au	E aej@aej.com.au	
Nominated Architect St	even Bayer Reg. No. 5	880

	DRAWING TITLE: Planting Palette					
nue,	SCALE: @ B1 1:1	'N: :hor	CHECKED: Checker	16.1	: 12.2019	
	PROJECT No:	I	DWG No:			ISSUE:
	17-0049		D	4/57		1

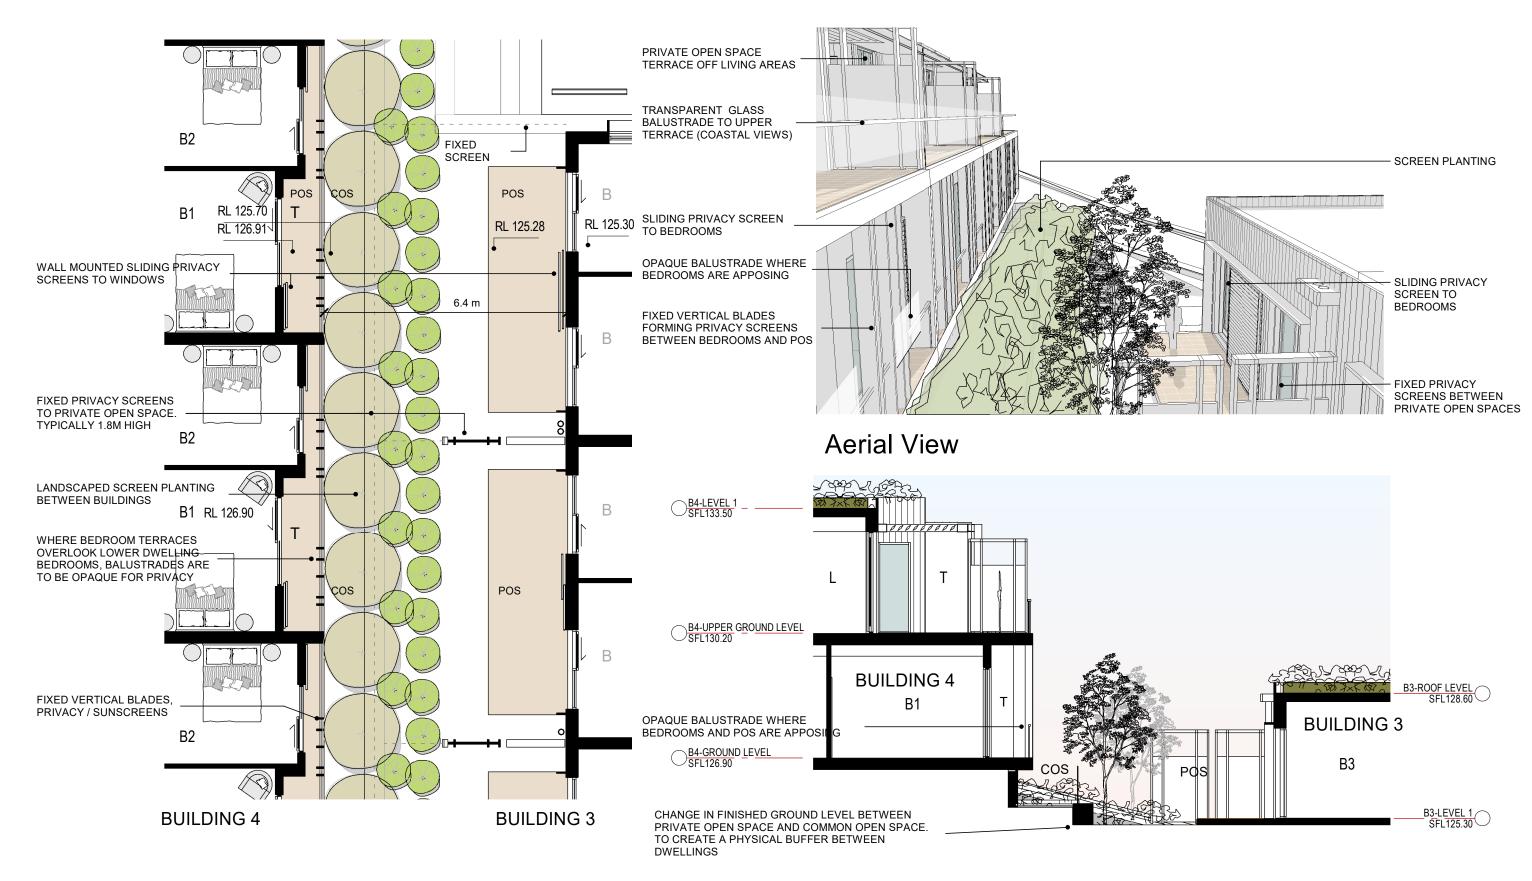

Part Plan - BUILDINGS 3 AND 4

Section

Proposed Residential Development THE COSGROVE Surewin Parkview Pty Ltd Lot 90 in D.P. 1086429, 14 Cosgrove Avenue, Keiraville, NSW, 2500

			,			
	REV.	DESCRIPTION	DATE	DRAWING TITLE	PROJECT #: 17-004	19
	1	Development Application	16.12.2019		SCALE: 1:100@	A3
				Typical Dwelling	DRAWN: EJ CHECK	ED: MFJ
					DRAWING NO.	REVISION
				Privacy Review		
				, ,	DA/100	1
						1
www.aej.com.au aej@aej.com.au				LICE WRITTEN DIMENSIONS ONLY DO NOT SOME OFF DRAW	UNICO	
				USE WRITTEN DIMENSIONS ONLY - DO NOT SCALE OFF DRAW	INGS	

COPYRIGHT OF TILMENT PTY LTD (ACN 003 163 451) trading as EDMISTON JONES GBB © 2016

CAUTION www.dialbeforeyoudig.com.au PART LOT 1 ONLY APPARENT SERVICES HAVE BEEN LOCATED BY SURVEY. NO SEARCH OF PUBLIC UTILITIES HAS BEEN CARRIED OUT TO DETERMINE THE LOCATION OF ANY UNDERGROUND SERVICES SUCH AS TELSTRA, POWER, GAS, SEWER OR WATER. AS SUCH BEFORE CARRYING OUT ANY DESIGN OR CONSTRUCTION WORK YOU NEED TO DIAL 1100 BEFORE YOU PROCEED DP 1188267 TREES HERE NOT / LOCATED BY SURVEY NOTE:

• FOR SPOT LEVEL INFORMATION SEE 3D DIGITAL MODEL

REPLAYED NAME IN 3D DIGITAL MODEL FOR FEATURE DESCRIPTION SEE LAYER NAME IN 3D DIGITAL MODEL 0

> GROUP OF 60+ TREES

BOUNDARY TABLE No. BEARING DIST 1 147°24' 18.62 2 279°24' 7.01 3 | 189°24' | 3.05 1 & 2 STOREY DP 419934 BRICK HOUSE AVENUI ANDREW,

CAUTION:
THE NORTH POINT ORIENTATION SHOWN HEREON HAS BEEN TAKEN FROM UNDERLYING CADASTRAL PLANS ONLY. NO ATTEMPT HAS BEE MADE TO DETERMINE ITS RELATIONSHIP TO ETHER CURRENT MAGNETIC NORTH OR TRUE NORTH.

EXPLANATORY NOTES

. ONLY APPARENT SERVICES HAVE BEEN LOCATED BY SURVEY. NO SEARCH OF PUBLIC UTILITIES OR SUB-SURFACE INVESTIGATION HAS BEEN CARRIED OUT TO DETERMINE THE LOCATION OF ANY UNDERGROUND SERVICES SUCH AS COMMUNICATIONS, ELECTRICITY, GAS, WATER OR SEWER. SEE THE ATTACHED DIAL BEFORE YOU DIG CAUTION IN THIS PLAN SPACE. NO INVESTIGATION OF LOCATION OF ANY FOOTINGS OR

RME

0

 \mathcal{H}

NN

NOT SURVEYED (HEAVILY VEGETATED & STEEP BANKS)

NOT SURVEYED (HEAVILY VEGETATED & STEEP BANKS)

2. SPOT LEVELS & CONTOURS REPRESENT GENERAL GROUND LEVEL ONLY, THEY GIVE AN APPROXIMATE REPRESENTATION ONLY OF THE SHAPE AND LEVELS OF THE GROUND SURFACE. CONTOURS DO NOT REPRESENT THE PRECISE LEVEL AT ANY PARTICULAR POINT EXCEPT WHERE A SPOT LEVEL IS SHOWN. SHOULD CRITICAL DESIGN FACTORS BE IN EXISTENCE THEN IT MAY BE NECESSARY TO OBTAIN SUPPLEMENTARY LEVELS TO

CONFIRM DESIGN CONSTRAINTS OR PARTICULARS. (TO THIS EXTENT IT SHOULD BE NOTED THAT THE CONTOUR INTERVAL IS $\underline{1.0}$ m) 3. CONTOURS ARE INTERPOLATED FROM SPOT LEVELS AS SHOWN & SHOULD BE USED AS A GUIDE ONLY. DO NOT RE-INTERPOLATE CONTOURS.

4. PLEASE NOTE THAT NO BOUNDARY DEFINITION SURVEY HAS BEEN UNDERTAKEN FOR THIS PLAN AND NO BOUNDARIES HAVE BEEN MARKED. BOUNDARIES ARE SHOWN IN APPROXIMATE LOCATION ONLY. DIMENSIONS AS SHOWN ON THE PLAN HAVE ONLY BEEN TAKEN FROM A COPY OF THE DEPOSITED PLAN AND NOT VERIFIED BY FIELD SURVEY. THE DIMENSIONS CAN ONLY BE VERIFIED BY UNDERTAKING A COMPREHENSIVE BOUNDARY DEFINITION SURVEY TO ESTABLISH THE AVAILABLE DIMENSIONS OF THE PROPERTY.

5. RELATIONSHIP OF IMPROVEMENTS AND TREES TO BOUNDARIES IS DIAGRAMMATIC ONLY AS THEY HAVE NOT BEEN ACCURATELY DETERMINED. WHERE OFFSETS ARE CRITICAL THEY SHOULD BE CONFIRMED BY FURTHER SURVEY. THE CO-ORDINATES OF BUILDING CORNERS WERE DETERMINED BY TOPOGRAPHIC SURVEY AND THEREFORE ARE APPROXIMATE ONLY.

6. TREE CANOPIES & TRUNKS ARE POSITIONED FOR DIAGRAMATIC PURPOSES ONLY. THE CANOPY & TRUNK SIZES SHOWN ON THIS PLAN ARE APPROXIMATE ONLY.

7. ORIGIN OF LEVELS IS AUSTRALIAN HEIGHT DATUM (A.H.D.) DERIVED FROM PM 4445, RL 61.272 (AHD, SOURCE - SCIMS).

8. THIS PLAN & ACCOMPANYING DIGITAL MODEL HAS BEEN PREPARED FOR MMJ - WOLLONGONG - ITS USE IS LIMITED TO SITE ANALYSIS MATTERS &

9. THIS PLAN IS TO BE READ IN CONJUNCTION WITH THE README FILE ON THE ACCOMPANYING DIGITAL TRANSFER AND THE PDF FILE ATTACHED.

			SCALE	1:600			
	0	8	16	24	32	40	
			Met	res			
COPYRIG	HT: Co	ncepts an	d information	on containe	d within the	ese drawir	ngs :

	ISSUE	AMENDMENT	DRAWN	DATE	LandTeam Austral
SCALE 1:600	A	INITIAL ISSUE	JAK	30/03/17	ABN 35 300 283 592
	В	TREE NUMBERS ADDED	TJ	15/10/19	Wollongong Office
	С	APZ LINE ADDED	AG	17/10/19	Postal: PO Box 353
0 8 16 24 32 40	D	ADDITIONAL TREES ADDED	AJC	08/11/19	
Metres	Е	APZ LINES REMOVED	AG	06/12/19	p: (02) 4296 7055 f: (02) 4297 1163
COPYRIGHT: Concepts and information contained within these drawings and related documents are the copyright of LandTeam Australia Pty Ltd. Unauthorised					e: wollongong@landte
copying of part or whole of the document(s) is a breach of this copyright.					www.landteam.com.au

DP 1086429

752





SURVEYED

96

DP 30903

DETAIL & CONTOUR SURVEY PLAN LOT 90 IN D.P. 1086429 No. 14 COSGROVE AVENUE, KEIRAVILLE

SUREWIN PTY LTD

No. 2


1 & 2 STOREY


BRICK HOUSE


SURVEYED: NH/MS ISSUE DRAWN: JAK CHECKED: R.VDZ DRAWING No. 209408-TS01 DATUM AHD CONTOUR INTERVAL 1m DATE SURVEYED 23-27/03/2017 SHEET 1 OF 1 SHEET(S)

Liability limited by a scheme approved under Professional Standards Legislation

FILE NAME: 209408 TS01_E.dwg

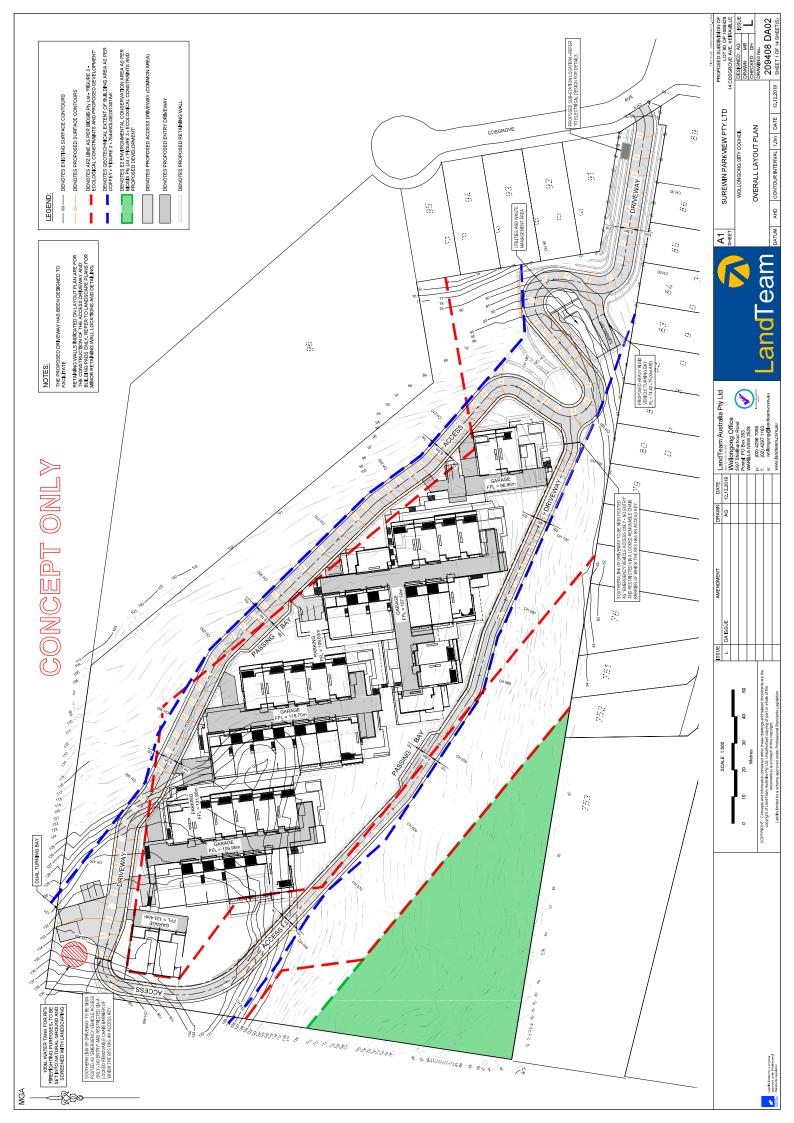

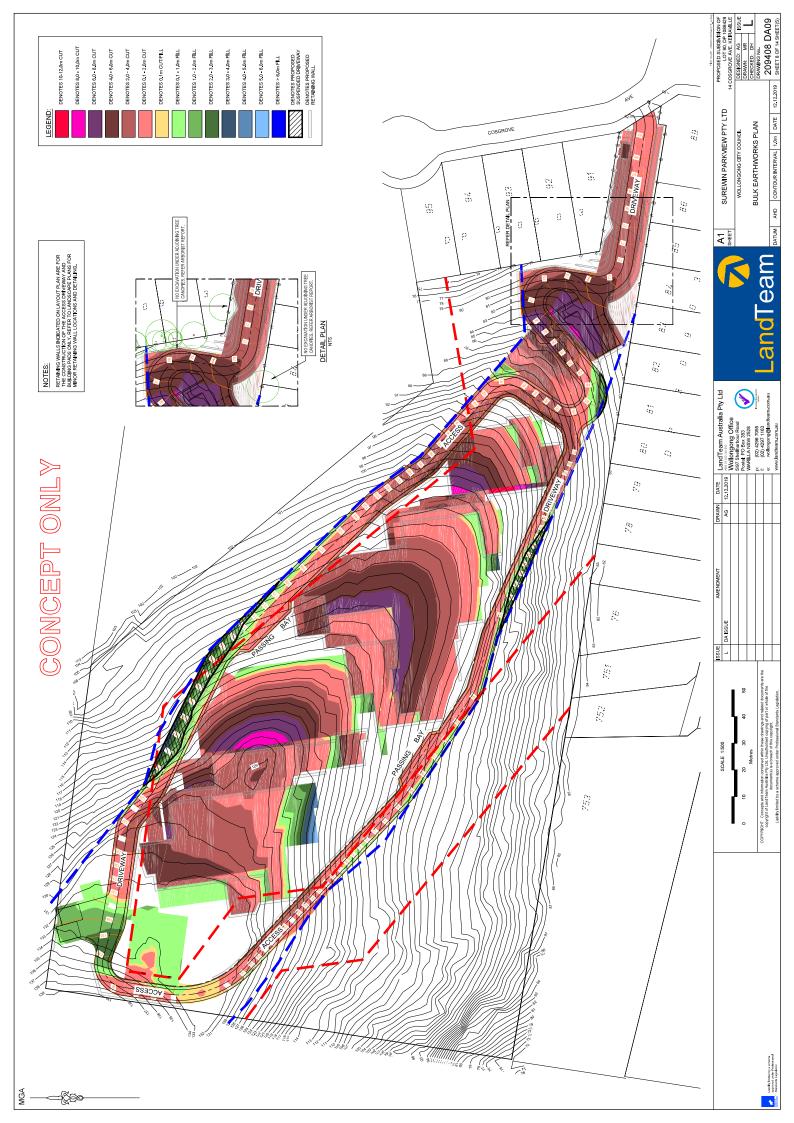

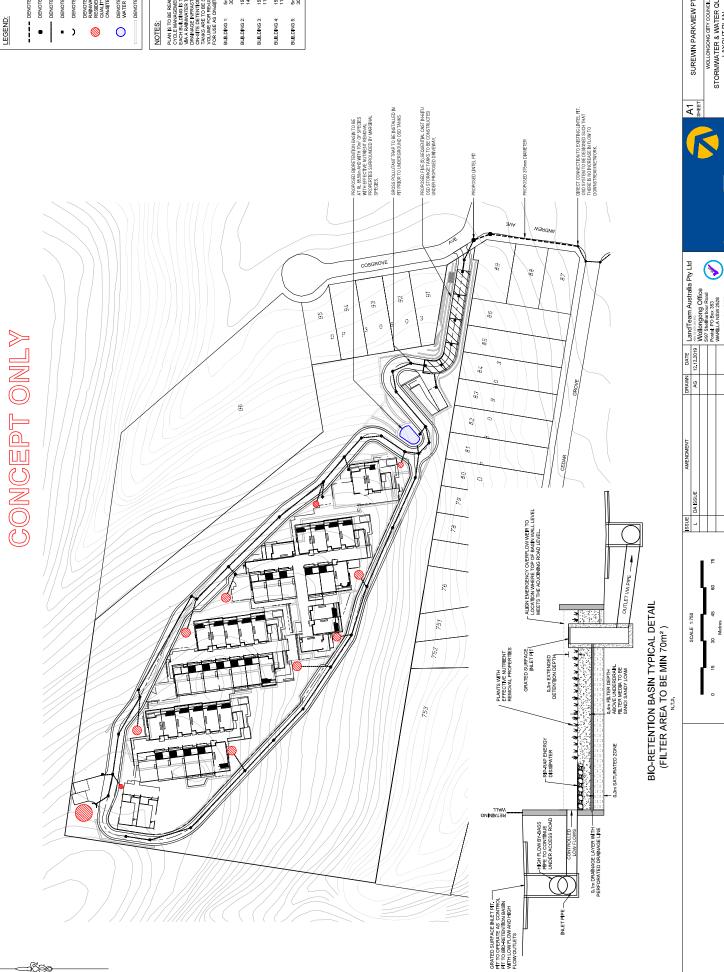

---- DENOTES TRUNK STORMWATER DRAINAGE LINE

DENOTES TRUNK STORMWATER PIT

DENOTES STORMWATER DRAINAGE LINE DENOTES STORMWATER PIT

DENOTES HEADWALL

DENOTES PROPOSED UNDERGROUND
RESIDENTAL RELAGE FOR BOTH
RESIDENTAL RELAGE (AS PER BASIX & WATER
OUALITY RECUREMENTS) AND STORMWATER
ON SITE DETENTION RECUIREMENTS.

DENOTED PROPOSED BIO-BASIN, REFER TO WATER CYCLE REPORT FOR DETAILS.

DENOTES PROPOSED RETAINING WALL

AND IS TO BE REPORT COMMUNION WITH WHERE OF CLE MANAGEMENT STUDY, WHO PREPORT IN COLOR BUILDING AREA THEATED WAS ARRESTED WITH A RAHMWITH THANK THEN TO COMMETTED WITH A RAHMWITH THANK THEN THE COMMETTED WITH COMMET THANK THEN THE COMMETTED WITH COMMETTED WAS WITH COMMETTED WITH COMMETTED WITH COMMETTED WITH COMMETTED WI

15m3 PERMANENT 140m3 TEMPORARY 15m3 PERMANENT 110m3 TEMPORARY

15m3 PERMANENT 110m3 TEMPORARY

5m³ PERMANENT 30m³ TEMPORARY

Land Feam

p. (02) 426 7055 Incompanie f. (02) 4297 1163 e. vollongong@landteam.com.au www.kandteam.com.au

FIGHT: Concepts and information contained within these drawings and related documents are the copyright of Land Team Australe by U.B. Unarbrinded opting of part or whole of the Occuments is a breach of this copyright.


Metres

15


SUREWIN PARKVIEW PTY LTD

PROPOSED SUBDIVISION OF LOT 90, DP 108429 14 COSGROVE AVE, KEIRAVILLE WOLLONGONG CITY COUNCIL
STORMWATER & WATER QUALITY
LAYOUT PLAN


DATUM AHD CONTOUR INTERVAL \cdot DATE 12.12.2019 SHEET 9.0F 14 SHEET(S)

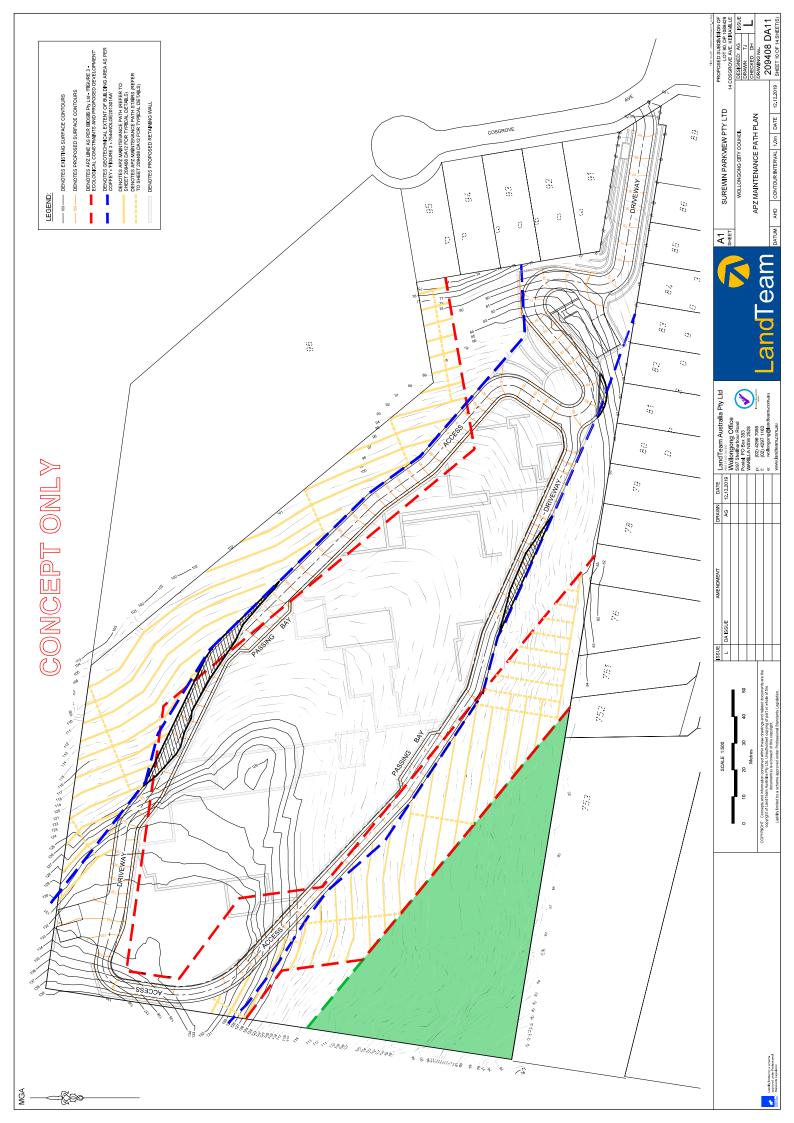

CONCEPT ONLY

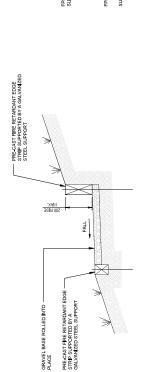




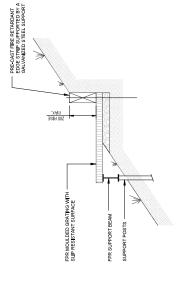

MAINTENANCE ACCESS PATH - PARALLEL TO CONTOUR TYPICAL SECTION 2 (> 33% - < 66%)

NTS

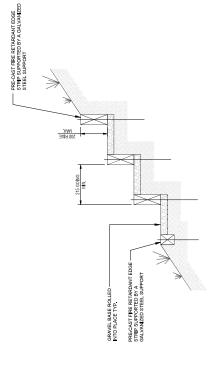

MAINTENANCE ACCESS STAIRS - PERPENDICULAR TO CONTOUR TYPICAL SECTION 3 (GENERALLY < 66%)



DATE LandTeam Australia Pty Ltd

DRAWN AG 12

ISSUE L DAISSUE

p: (02) 4296 7055 1197 (02) 4297 1163 e. vollongong@landteam.co AND MOREOUS OFFICE


5/97 Shellharbour Road
Postal: PO Box 353

WARILLA NSW 2528


	¥	0)	SUREWIN PARKVIEW PTY LTD	EW P1	7 LT		PROPOSED SUBDIVISION OF LOT 90, DP 1086429	ON OF 086429
	E E					140	14 COSGROVE AVE, KEIRAVILLE	WILLE
			WOLLONGONG CITY COUNCIL	COUNCIL			DESIGNED: AG	SSUE
							DRAWN: AJC	-
		400	A DOINGING TO THE	Ē	I V H	,	CHECKED: DH	۷
		AFA	APZ IMAINI ENANCE PATO DETAILS	Ĭ	Ì	0	DRAWING No.	
							209408 DA12	412
7	DATUM		CONTOUR INTERVAL		DATE	DATE 12.12.2019	SHEET 11 OF 14 SHEET(S)	EET(S)


WOLLONGONG GITY COUNCIL APZ MAINTENANCE PATH DETAILS	
--	--

OCPYRICHT. Concepts and information contained within these drawings and related documents are the copyright of Landfream Australia RPL Lib Landfreider dopying of part or sincle of the document(s) is a freed or this copyright. Liability Imriect by a scheme approved under Professional Standards Legislation.

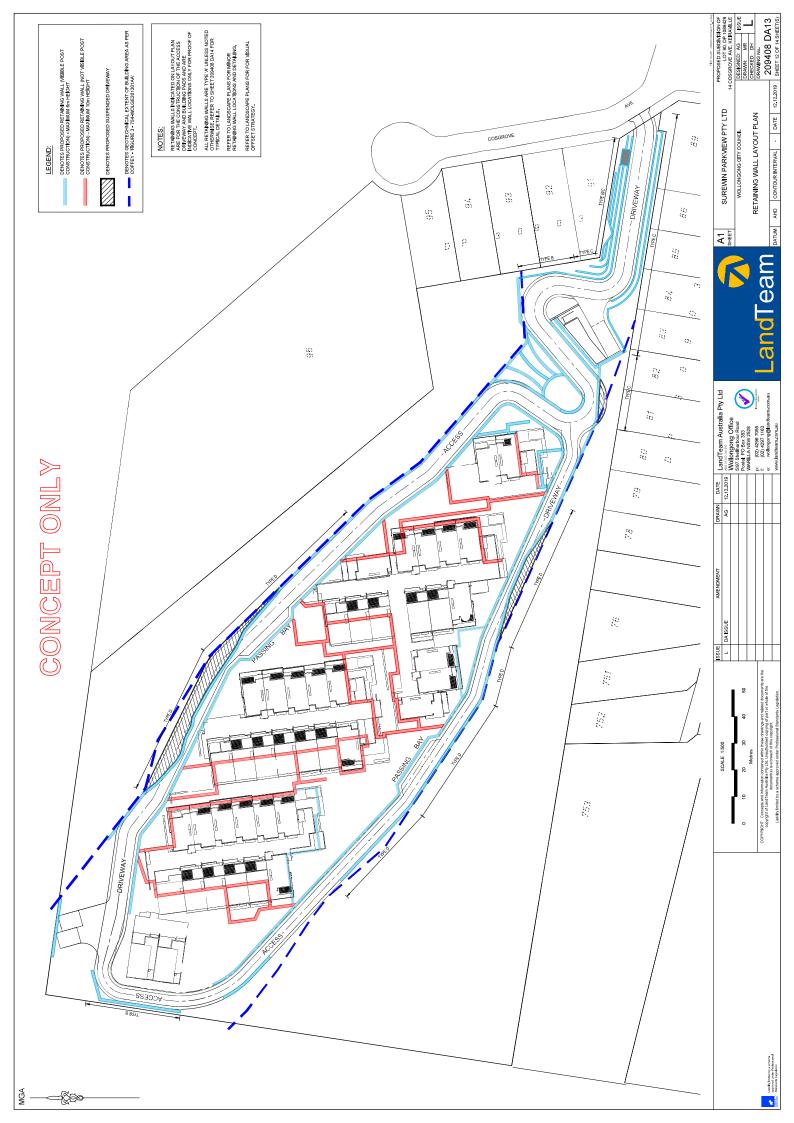

CONCEPT ONLY

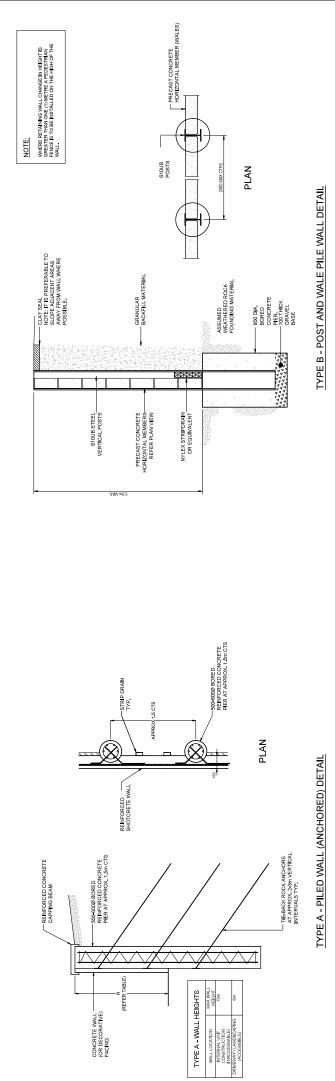


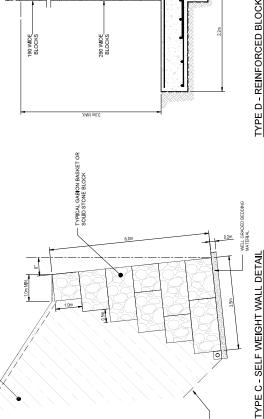

BACKFILL & WATERPROOFING.

200mm THICK COMPACTED CLAY SEAL.

- 150 THICK TOP SOIL - BACKFILL

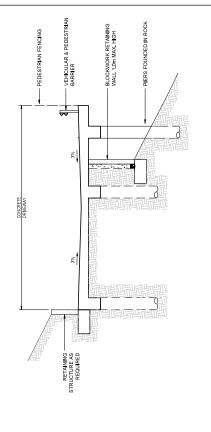

TYPE D - REINFORCED BLOCKWORK RETAINING WALL

– 90 Ø AGGREGATE DRAIN WITH SLEEVE.

SAFE TEMPORARY BATTER TO SUIT GROUND CONDITIONS TYPICALLY 45° UPON WHICH STANDARD DESIGNS ARE BASED, WALL TO BE REVIEWED FOR OTHER TEMPORARY BATTER SLOPES.

i i	1.0m > ABOVE GROUND LEVEL	A1 SUREWIN PARKVIEW	WOLLONGONG CITY COUR	STRUCTURAL DETA
	1.0m >	5		andTaam

DA ISSUE

ODPYRIGHT. Concepts and information contained within these drawings and related documents are the copyright of land team but and land team and document(s) is a breast of this copyright.

SUSPENDED DRIVEWAY SECTION DETAIL

	SHEET	SUREWIN PARKVIEW PLY LID		1
		MOLLONGONG CITY COUNCIL	_	
m 0 0		STRUCTURAL DETAILS	ဟ	
ממו	10000	The second of the second of the		1

						FLET MARE: 209438 DAGG DATE U. dwg	3100 DA15	L. Owg
7 ==	σ	SUREWIN PARKVIEW PTY LTD	EW F	٦٠ ل <u>۲</u>	41	PROPOSED SUBDIVISION OF LOT 90, DP 1086429 14 COSGROVE AVE, KEJRAVILLE	ISION (10864 RAVIL	무용의
		WOLLONGONG CITY COUNCIL	COUNC	_		DESIGNED: AG	ISSUE	삥
						DRAWN: AJC	_	
		T T T T T T T T T T T T T T T T T T T	i i			CHECKED: DH	_	
		STRUCTURAL DETAILS	Ĭ.	ų		DRAWING No.		
						209408 DA14	4	4
MUTA		CONTOUR INTERVAL		DATE	DATE 12.12.2019	SHEET 13 OF 14 SHEET(S)	SHEET	<u>و</u>

